# LAKEVIEW MIDDLE SCHOOL ROOF REPLACEMENT

3801 OLD BUNCOMBE ROAD GREENVILLE, SC 29617

RAYMOND PROJECT NO. GSP1010.079 CLIENT: GREENVILLE COUNTY SCHOOLS





### DRAWING INDEX

DWG NO	DRAWING TITLE	ISSUE DATE	REV NO.	LATEST ISSUE
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G-003	GENERAL NOTES	02/21/2024		02/21/2024
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XA-102	DEMOLITION ROOF PLAN - ROOF AREA A1-A6, B1-B2, C1-C2	02/21/2024		02/21/2024
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S-101	WIND ZONE ROOF PLAN - ROOF AREA A7 - A10 & B3	02/21/2024		02/21/2024
S-102	WIND ZONE ROOF PLAN - ROOF AREA A1-A6, B1-B2, C1-C2	02/21/2024		02/21/2024

## SPECIFICATIONS

A SEPARATE PROJECT MANUAL (SPECIFICATION) IS:

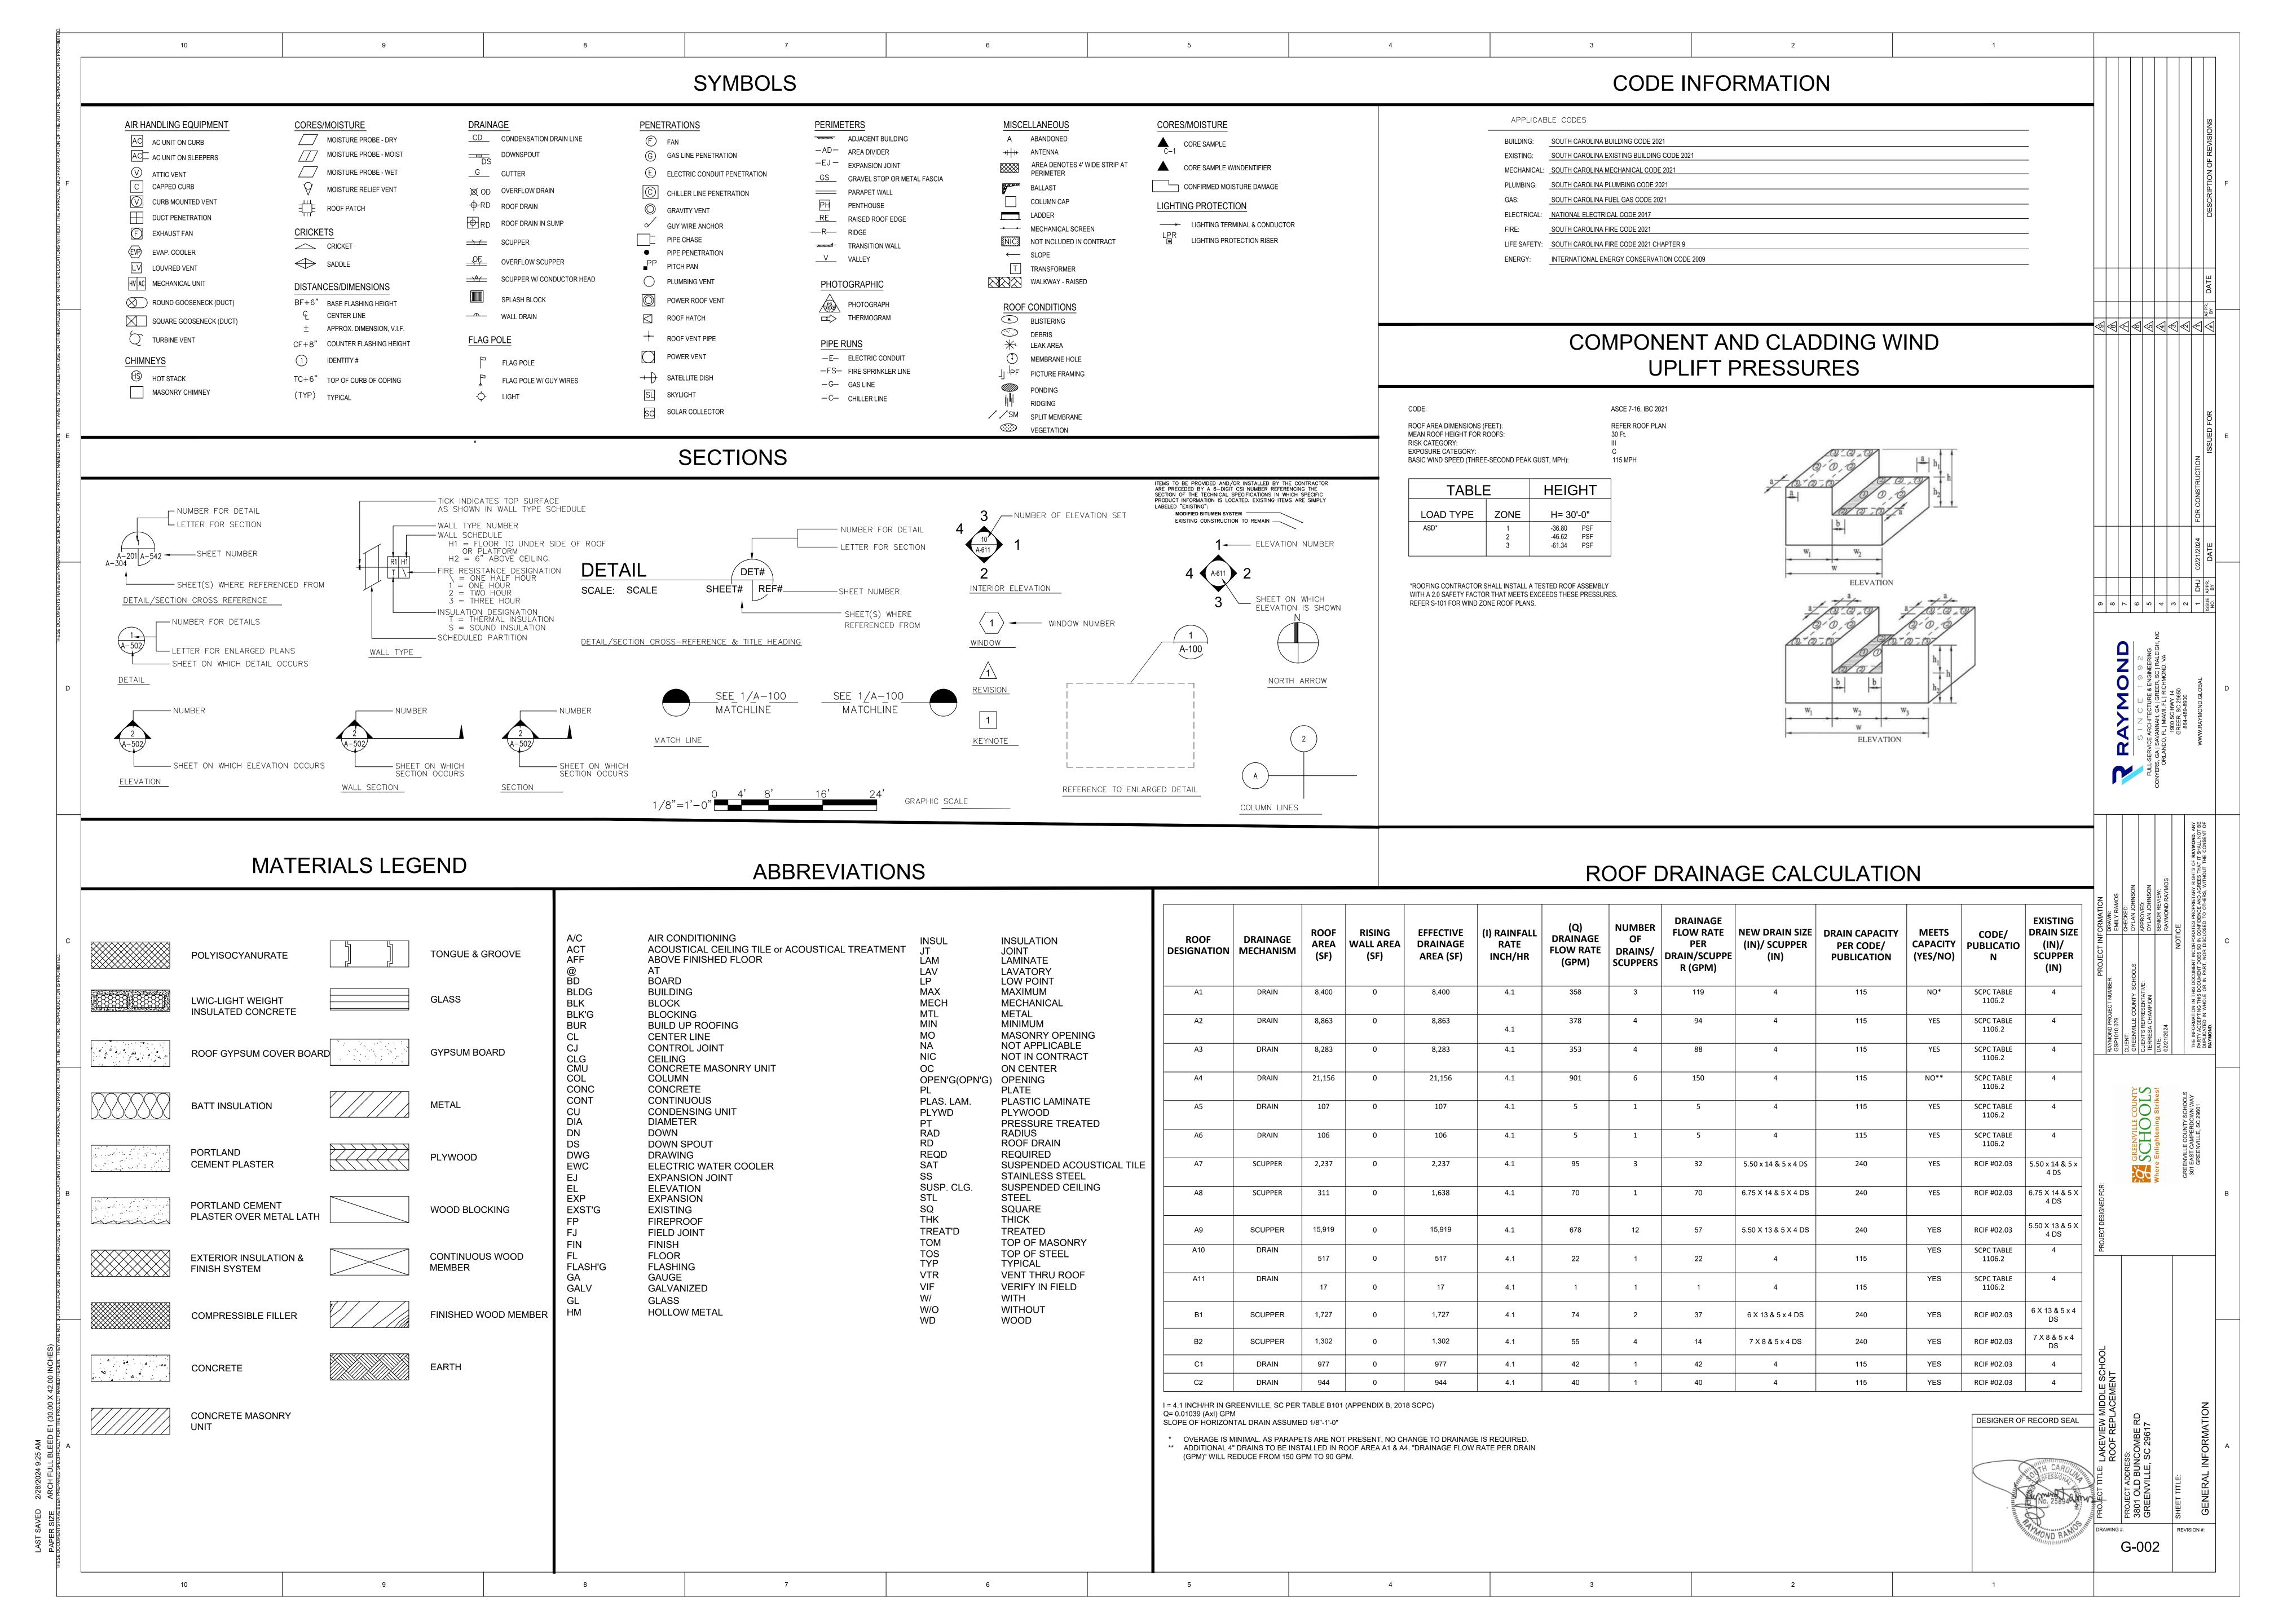
NOT INCLUDED

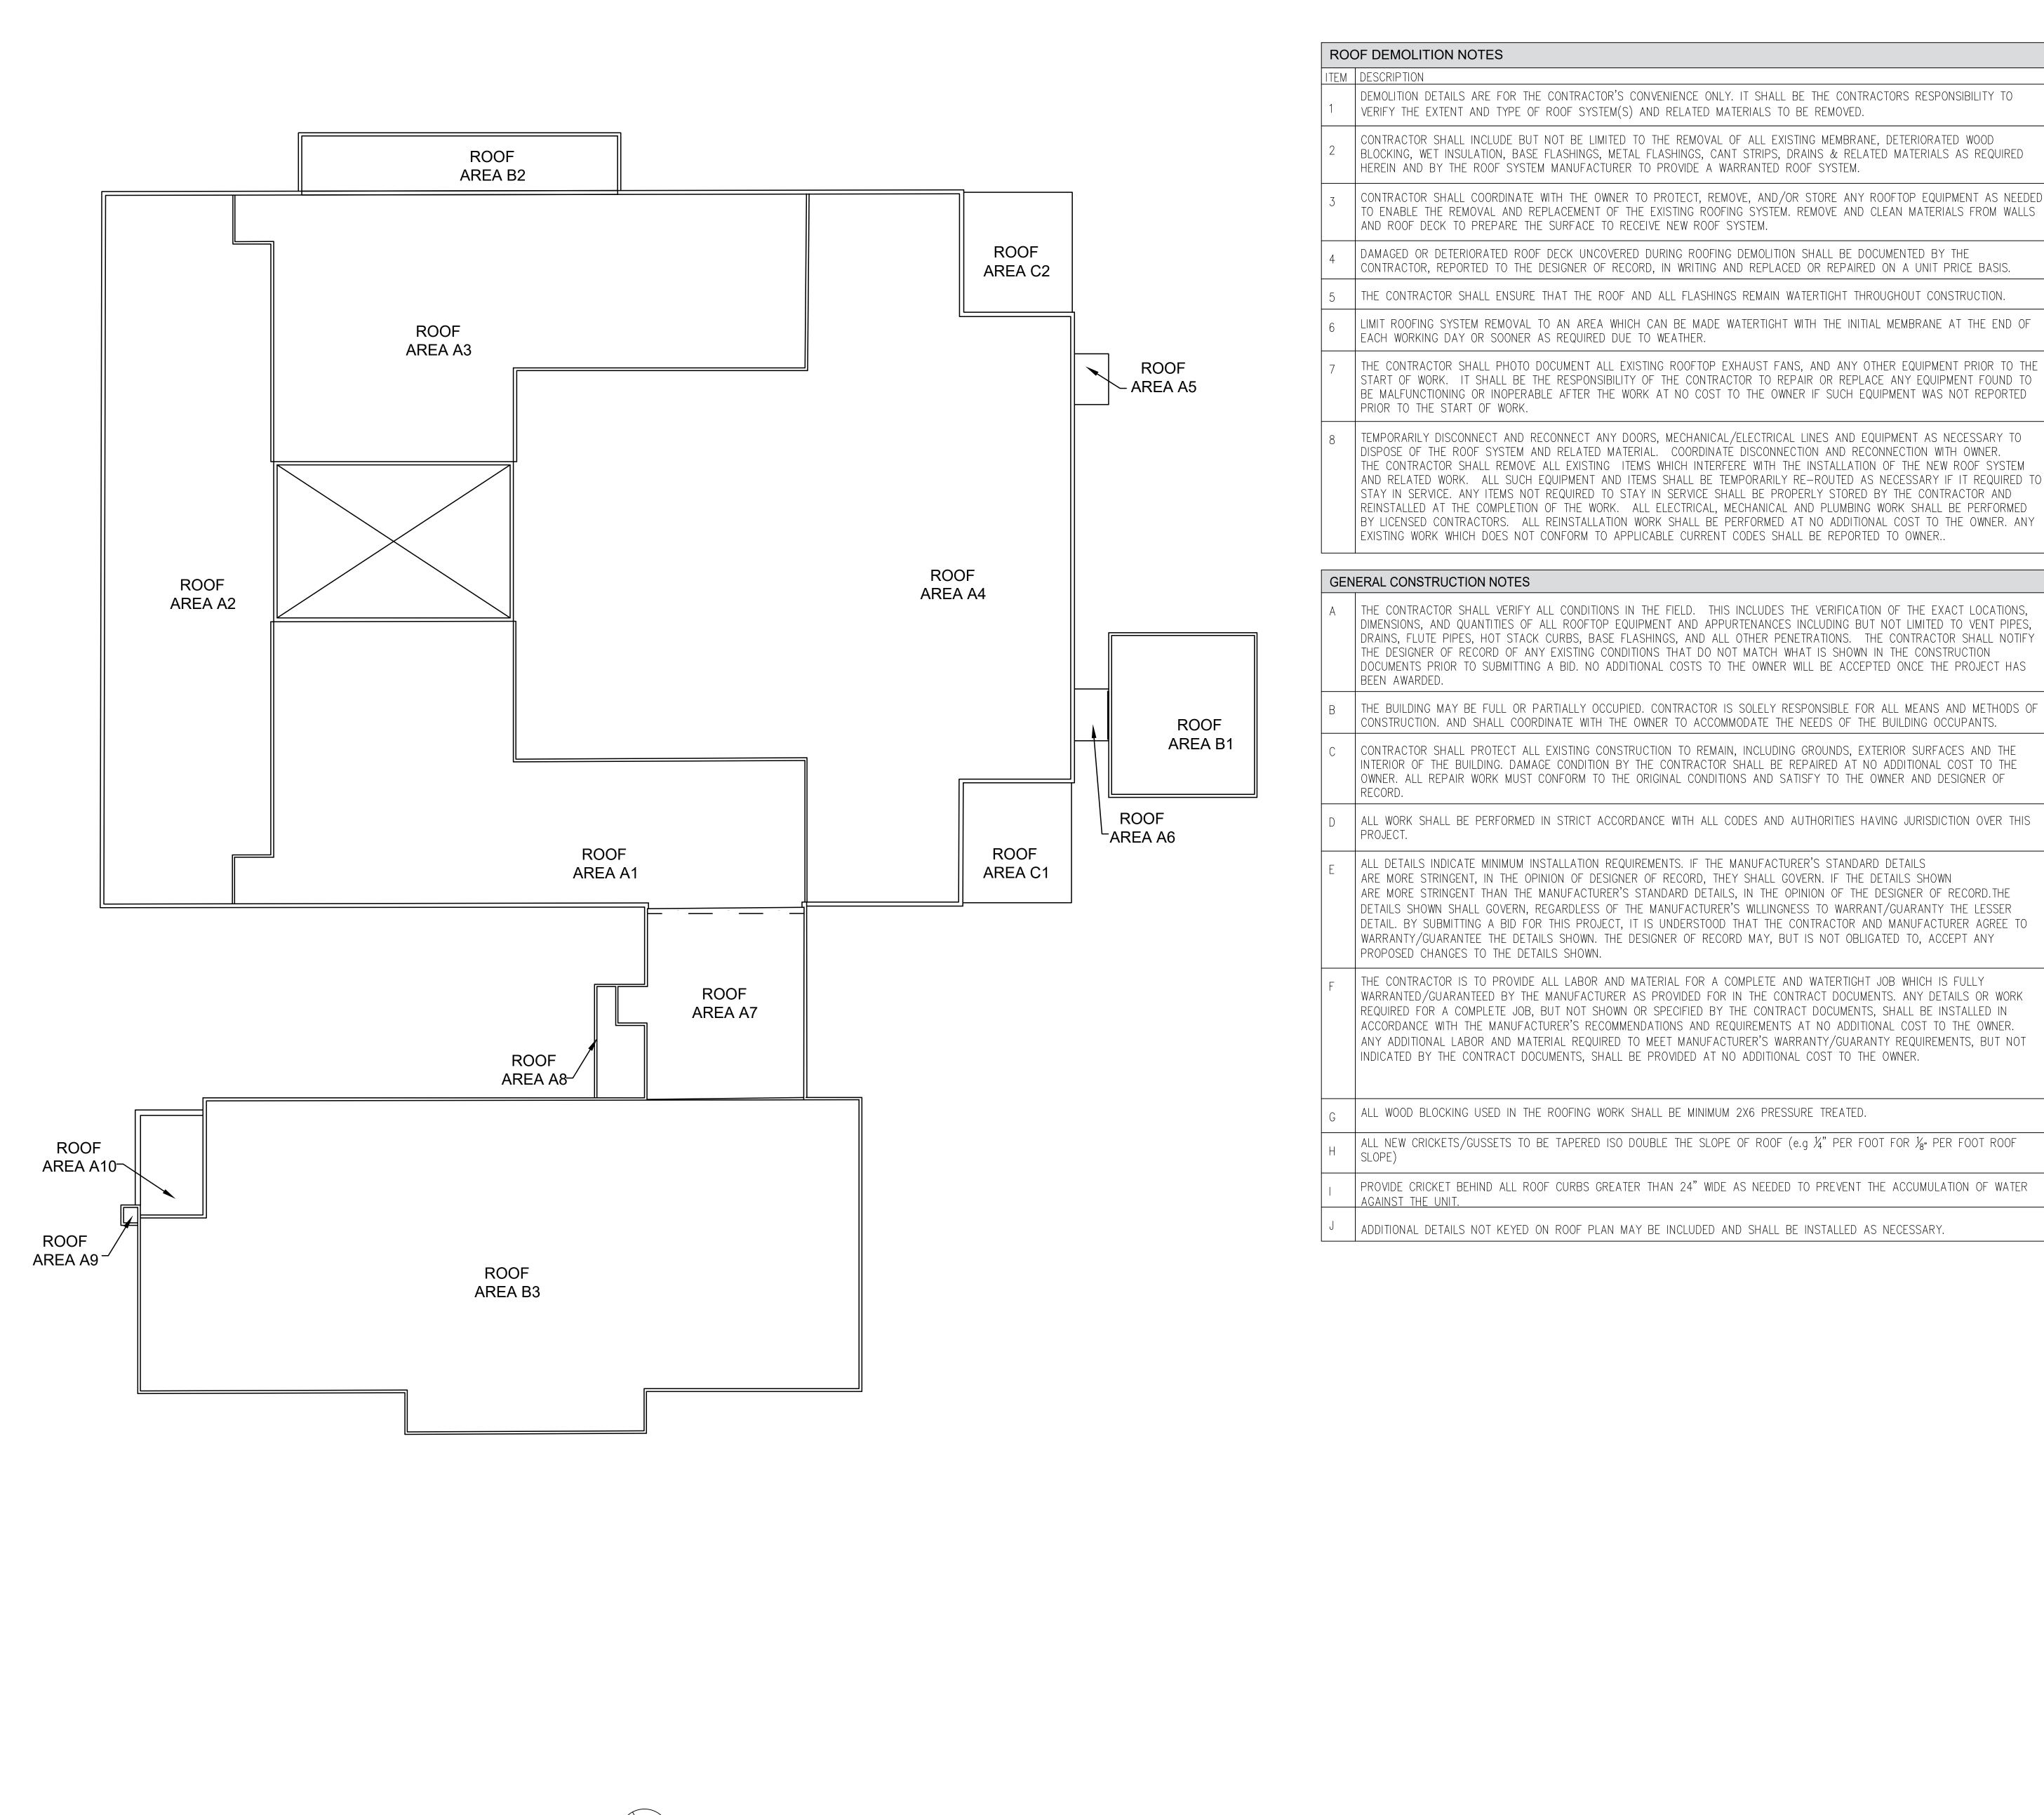
AS PART OF THIS PROJECT.

## PROJECT SCOPE

REFER TO SPECIFICATION DOCUMENT FOR PROJECT SCOPE. WORK UNDER THIS CONTRACT CONSISTS OF FURNISHING ALL LABOR, MATERIALS AND EQUIPMENT NECESSARY TO PERFORM THE QUALITY REMEDIAL ROOF RECOVER AT LAKEVIEW MIDDLE SCHOOL. REFER TO SPECIFICATION SECTION 01 11 00 "SUMMARY OF WORK" FOR MORE INFORMATION.







GENERAL SCOPE OF WORK

1. ROOF REPLACEMENT WITH ASSOCIATED REQUIREMENTS.

2. REFER TO SPECIFICATIONS DOCUMENT FOR ADDITIONAL INFORMATION.

### PROTECTION NOTES

- 1. THE BUILDING WILL REMAIN FUNCTIONAL THROUGHOUT THE CONSTRUCTION PERIOD. CONTRACTOR SHALL TAKE ALL NECESSARY PRECAUTIONS TO PROTECT CONTENTS AND OCCUPANTS.
- 2. NO MORE ROOFING SHALL BE REMOVED THAN CAN BE INSTALLED, WITH THE COMPLETE NEW ROOF SYSTEM EACH DAY, EXCEPT AS OTHERWISE APPROVED.
- 3. THE BUILDING SHALL BE WATERTIGHT AT THE END OF EACH DAY'S CONSTRUCTION AND WHEN INCLEMENT WEATHER THREATENS.
- 4. THE CONTRACTOR SHALL TAKE ALL NECESSARY PRECAUTIONS TO PROTECT THE BUILDING, EXTERIOR, INTERIOR AND GROUNDS, INCLUDING ANY LANDSCAPING, AND ALL PROMENADE CONCRETE WITHIN THE PROJECT SCOPE.
- ANY SURFACES STAINED, MARKED, MARRED, OR DAMAGED BY THE CONTRACTOR SHALL BE RETURNED TO ORIGINAL CONDITION AND TO MATCH ADJACENT SURFACES.
- THE SEQUENCE OF WORK SHALL MINIMIZE CONSTRUCTION TRAFFIC ON THE NEW WORK.

#### GENERAL NOTES

- 1. ALL BUILDING DIMENSIONS, EXISTING CONDITIONS, ITEM LOCATIONS, AND SIZES AND QUANTITIES OF PENETRATIONS ARE APPROXIMATE AND SHALL BE FIELD VERIFIED BY THE CONTRACTOR.
- 2. LAYDOWN/STORAGE AREA IS LIMITED AND SHALL BE AS APPROVED BY THE OWNER.
- 3. PRIOR TO PERFORMING WORK, THE CONTRACTOR SHALL INSPECT THE WORK SITE AND EXISTING CONSTRUCTION FOR POTENTIAL SAFETY HAZARD AND PROVIDE FOR THE SAFETY AND PROTECTION OF WORKERS AND OCCUPANTS THROUGHOUT COURSE OF WORK. COMPLY WITH OSHA AND LOCAL BUILDING CODE REQUIREMENTS.
- 4. BUILDING ACCESS IS RESTRICTED AND ALLOWED ONLY AS REQUIRED TO ACCOMPLISH CONTRACT WORK. COORDINATE ANY REQUIRED ACCESS WITH THE OWNER.
- 5. WORK INCLUDES ROOF REPLACEMENT OF ONLY THE INDICATED ROOF AREAS
- 6. SITE SHALL BE CLEANED AND SECURED ON A DAILY BASIS.

SINCE 1992

FULL-SERVICE ARCHITECTURE & ENGINEERING
CONYERS, GA | SAVANNAH, GA | GREER, SC | RALEIGH, NC
ORLANDO, FL | MIAMI, FL | RICHMOND, VA
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GREER, SC 29650
864-489-8900
WWW.RAYMOND.GLOBAL

GREENVILLE COUNTY
Where Enlightening Strikes!
GREENVILLE COUNTY SCHOOLS
301 EAST CAMPERDOWN WAY

DESIGNER OF RECORD SEAL

PROJECT ADDRESS:
3801 OLD BUNCOMBE F
GREENVILLE, SC 29617

G#: REVIS

SITE PLAN
SCALE: N.T.S

		2		1						
		SHEET NOTES		LEGEND						
			EXIT	BUILDING EXIT						
	1.	CONTRACTOR SHALL PROTECT FIRE EXITS AT ALL TIMES DURING CONSTRUCTION. AT NO TIME SHALL AN EXIT BE BLOCKED BY MATERIALS, LADDERS, DEBRIS, OR OTHER.		MATERIAL STAGING AREA						SIONS
	2.	WHEN WORK IS OCCURRING DIRECTLY ABOVE AN EXIT A WORKER SHALL BE STAGED ON THE GROUND BY THE EXIT TO STOP WORK AS NEEDED TO ENSURE A SAFE ENVIRONMENT.								DESCRIPTION OF REVISIONS
	3.	MATERIAL STORAGE LOCATIONS SHALL BE COORDINATED WITH THE OWNER DURING CONSTRUCTION. MATERIALS MAN NEED TO BE MOVED THROUGH OUT THE SCHOOL YEAR TO ACCOMMODATE CHANGING OWNER USE. REFER TO SPECIFICATIONS FOR MATERIAL STORAGE REQUIREMENTS.								DESCRIPT
	4.	SCHOOL GROUNDS SHALL BE RESTORED TO THE CONDITIO THEY WERE IN PRIOR TO CONSTRUCTION.	N							
										DATE
L			I							APPR. BY
	THE REAL PROPERTY.				<b>(</b>	1	<b>⊚</b>	4	4	

SOUTH CAROLINA STATE DEPARTMENT OF EDUCATION

	Form F3	Re-Roofir	g Analysis			
Date: February 21, 2024						
SUBMITTAL:      Schematic		☐ Design Develo	pment		★ Construction Docum	ent
SC CODE EDITION: 2021 ICC CO	DE EDITION:	2021 ICC A	17.1 EDITION:	2017	OSF GUIDE EDITION	: 2023
PROJECT DESCRIPTION: [Brief Scope ROOF REPLACEMENT, REFER TO	of Work & Inclu	de project deliver	y method (i.e. CM	(R, etc.)]	VORK. DESIGN-BID-BU	ILD.
	BASIC RE-	ROOFING COL	E INFORMATI	ON		
DESIGNATED AREAS OF BUILDING	Building Code	Area 1	Area 2	Area	3 Area 4	Area 5
CONSTRUCTION CLASSIFICATION TYPE	Section 602	TYPE IIB				
Roof Construction including supporting beams & joist	Table 601	-	-	•	-	-
As Required, Hrs		0				
As Designed, Hrs		0				
Testing Agency & Design No. (UL, FM, etc.)		N/A				
Wall/Partition Key Code		N/A				

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Version May 2021

Version May 2021

SC STATE DEPARTMENT OF EDUCTION FORM F-3 PAGE 1
SCALE: N.T.S.

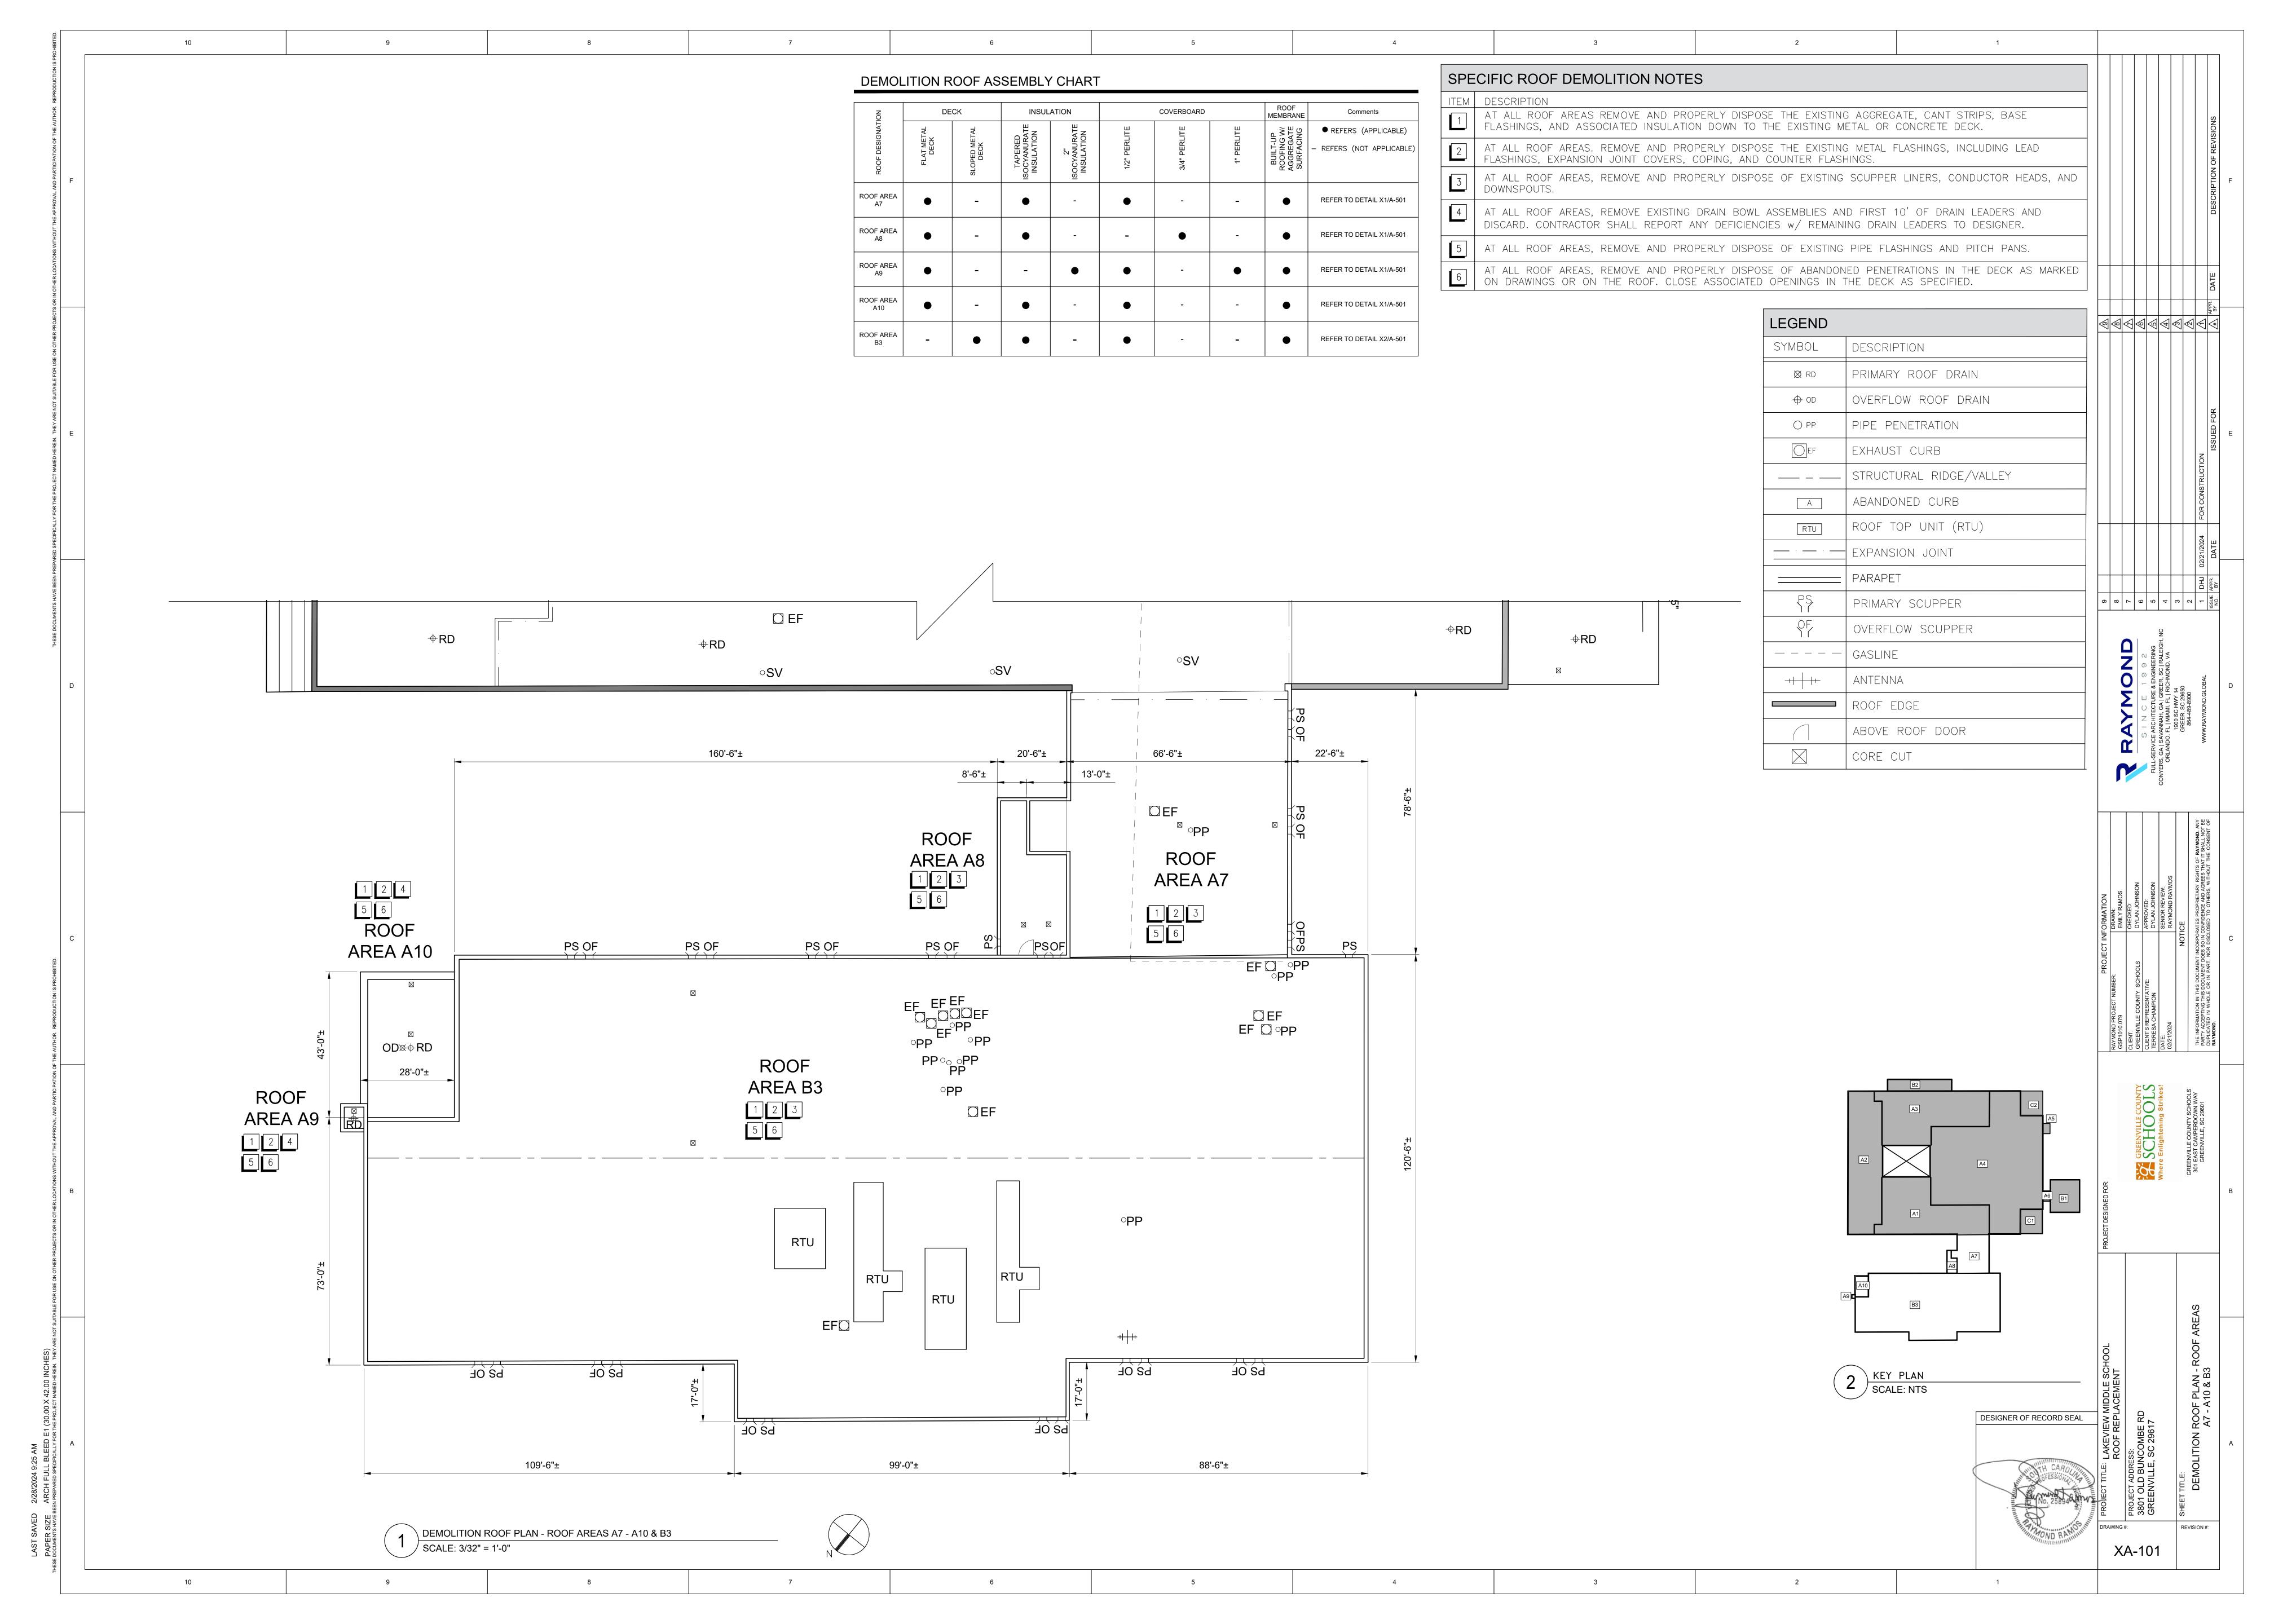
SOUTH CAROLINA

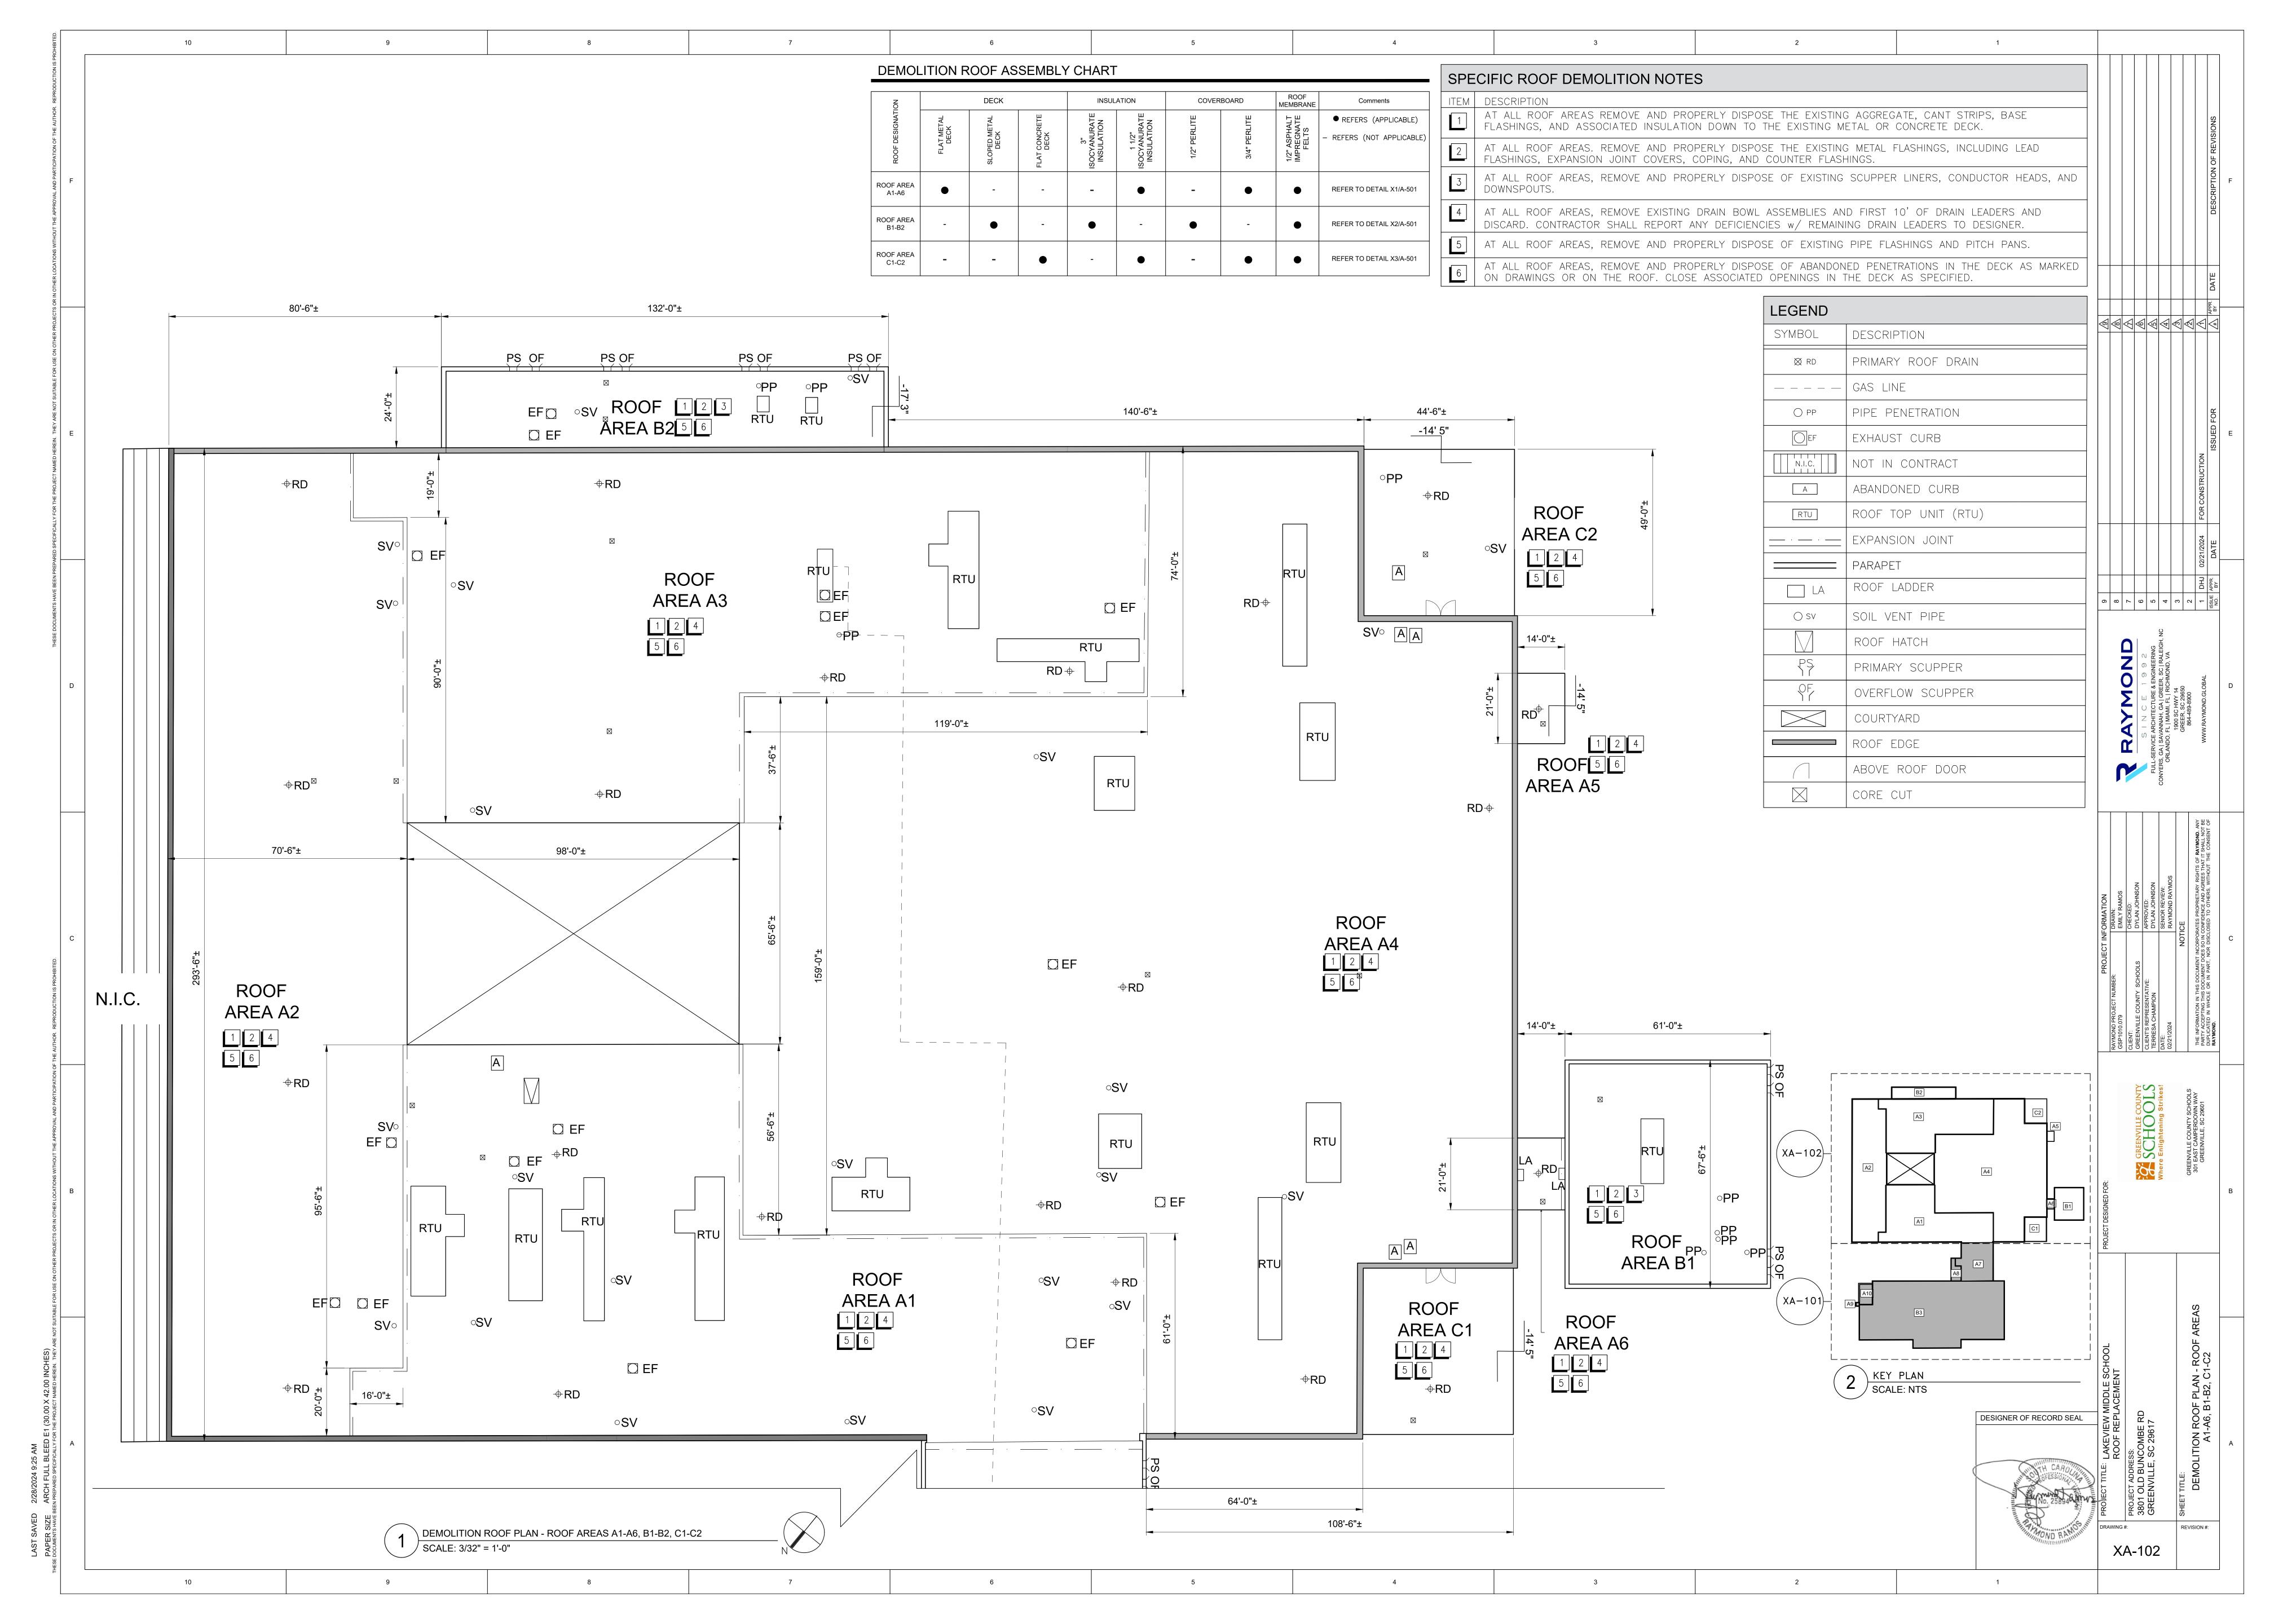
		Form F3 – R	te-Roofing Analysis
STRU	CTURAL DESIGN INFORMATION,	BUILDING	CONSTRUCTION DOCUMENTS
WIND LOADS	Analysis Procedure (ASCE 7 or SCBC 1609.6)	ASCE 7-16	I. Signed, sealed and dated drawings
	Basic design Wind Speed, MPH (3 sec gust IBC Fig 1609.3)	= V 115 MPH	II. Fully coordinated within and with the Project Manual.
	Exposure Category	В	
	Wind Importance Factor (ASCE 7 Table 1.5-2)	= I <sub>w</sub> RISK III	PROJECT MANUAL
	Internal Pressure Coefficient (ASCE 7)	0.18 = GC <sub>pi</sub>	I. Signed, sealed and dated
	External Pressure Coefficient (ASCE 7)	= GC <sub>p</sub>	II. Fully coordinated within and with the Construction Documents
ADDITI	ONAL QUESTIONS		
Preparany ac admin the bu	re a site plan showing the life safety plan during co iditional details on how the contractor will keep th istration informed about issues that may affect dai ilding	le school ily operations in	See below
Preparany ac admin the bu	re a site plan showing the life safety plan during co ditional details on how the contractor will keep th istration informed about issues that may affect da	le school ily operations in	See below No
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Preparany ac admin the but     Will the sum of the	re a site plan showing the life safety plan during co ditional details on how the contractor will keep th istration informed about issues that may affect dat ilding here be additional weight added to the existing stru	ne school ily operations in acture? ed? Confirm the current code?	No  MIN R-20  ADDITIONAL PRIMARY DRAINS WILL BE ADDED. OVERFLOW
Preparany ac admin the but     Will the statement of	re a site plan showing the life safety plan during conditional details on how the contractor will keep the istration informed about issues that may affect dailiding there be additional weight added to the existing structure will the insulation values be in areas being reroofs tion will meet current energy codes.	ne school ily operations in acture? ed? Confirm the current code?	No  MIN R-20  ADDITIONAL PRIMARY DRAINS WILL BE ADDED. OVERFLOW
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Preparany ac admin the but 2. Will the sum of the	re a site plan showing the life safety plan during conditional details on how the contractor will keep the intration informed about issues that may affect data ilding there be additional weight added to the existing structure will the insulation values be in areas being reroofed too will meet current energy codes. The existing roof drainage stay the same and meet convenience will the new roof assembly consist of?	ne school ily operations in acture? ed? Confirm the current code?	No  MIN R-20  ADDITIONAL PRIMARY DRAINS WILL BE ADDED. OVERFLOW SCUPPERS WILL BE ENLARGED TO MEET CODE REQUIREMENTS REFER TO DETAIL A, B, & C/A-501

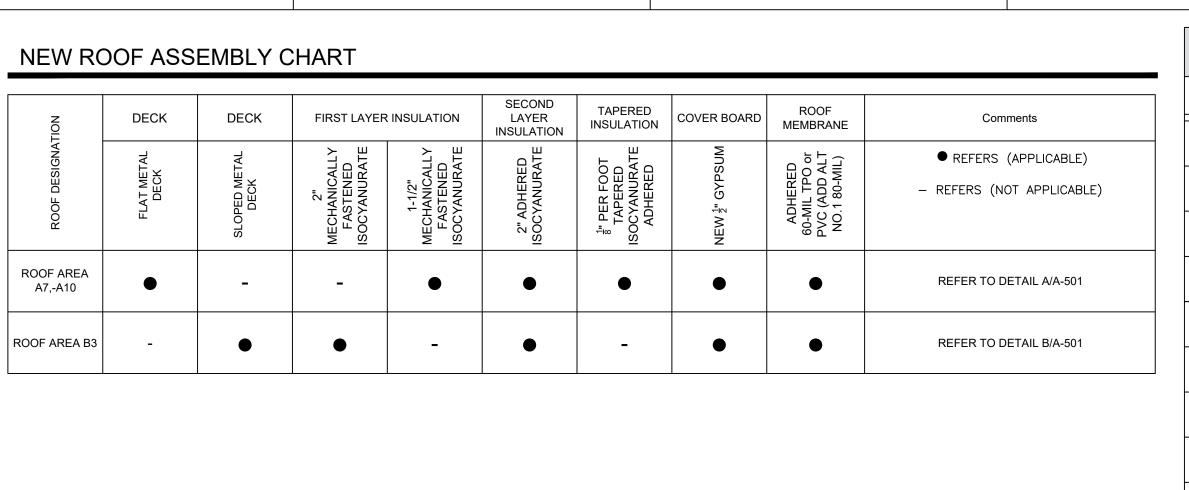
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DESIGNER OF RECORD SEAL

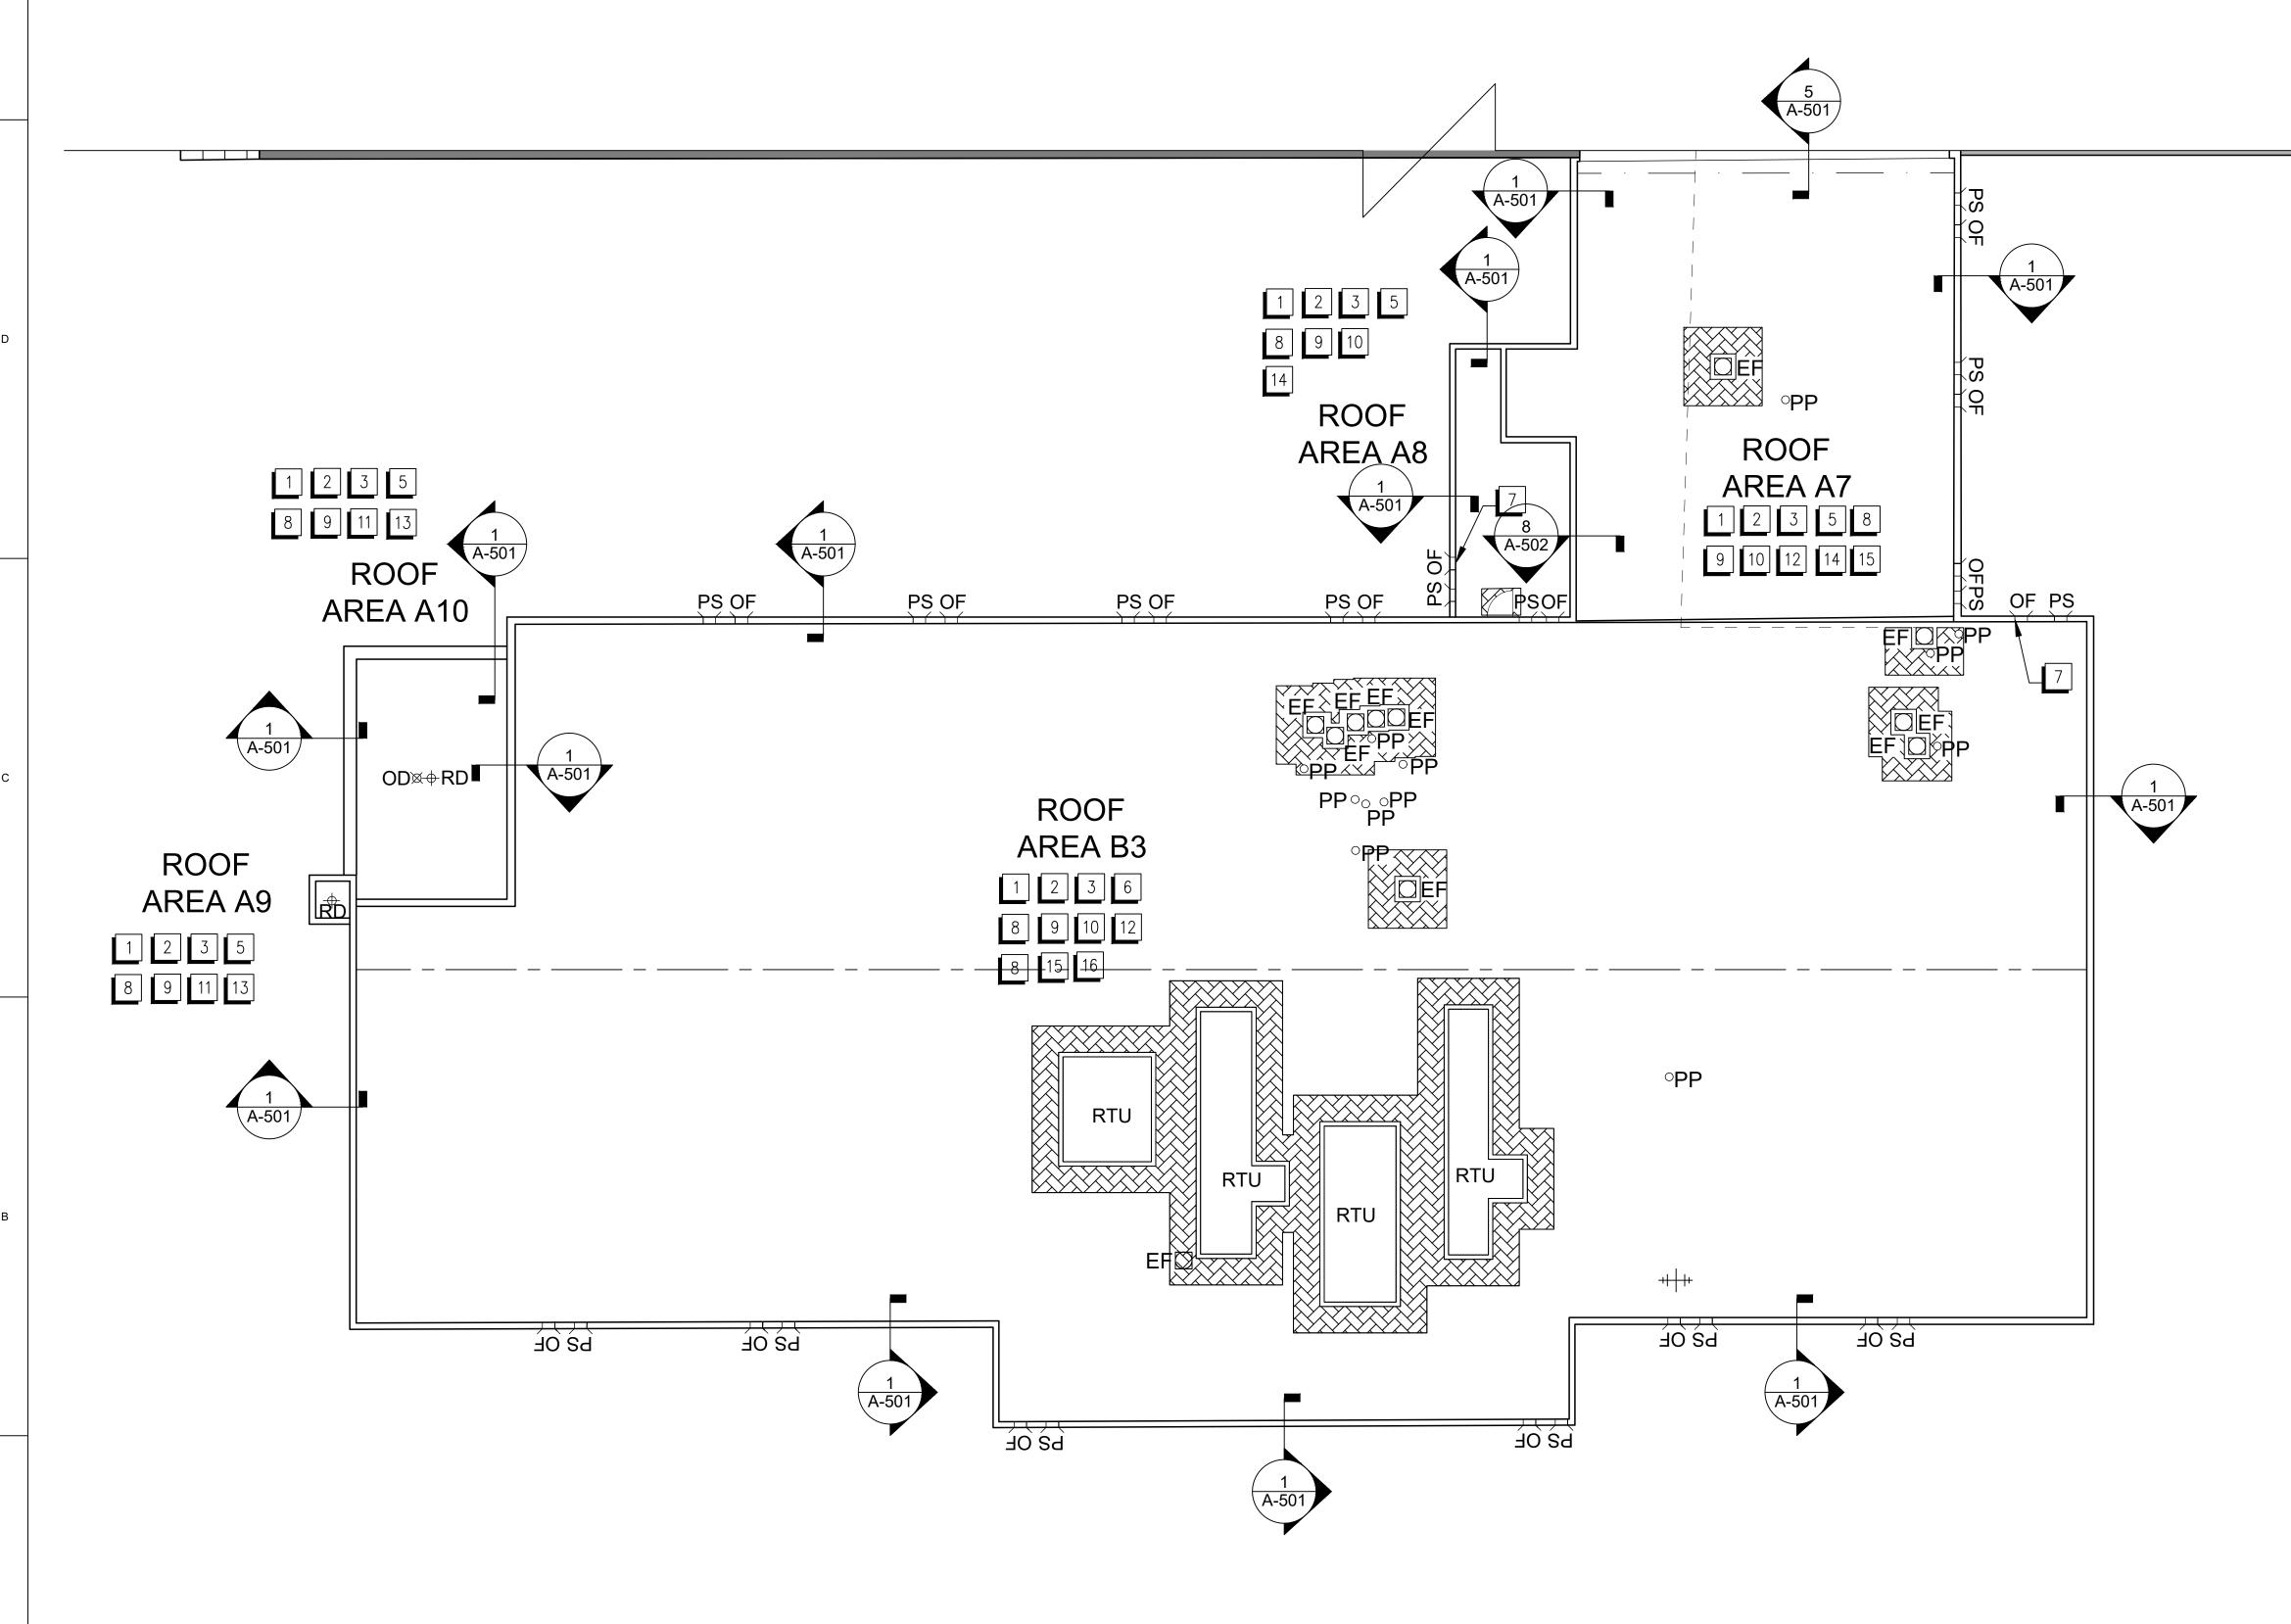


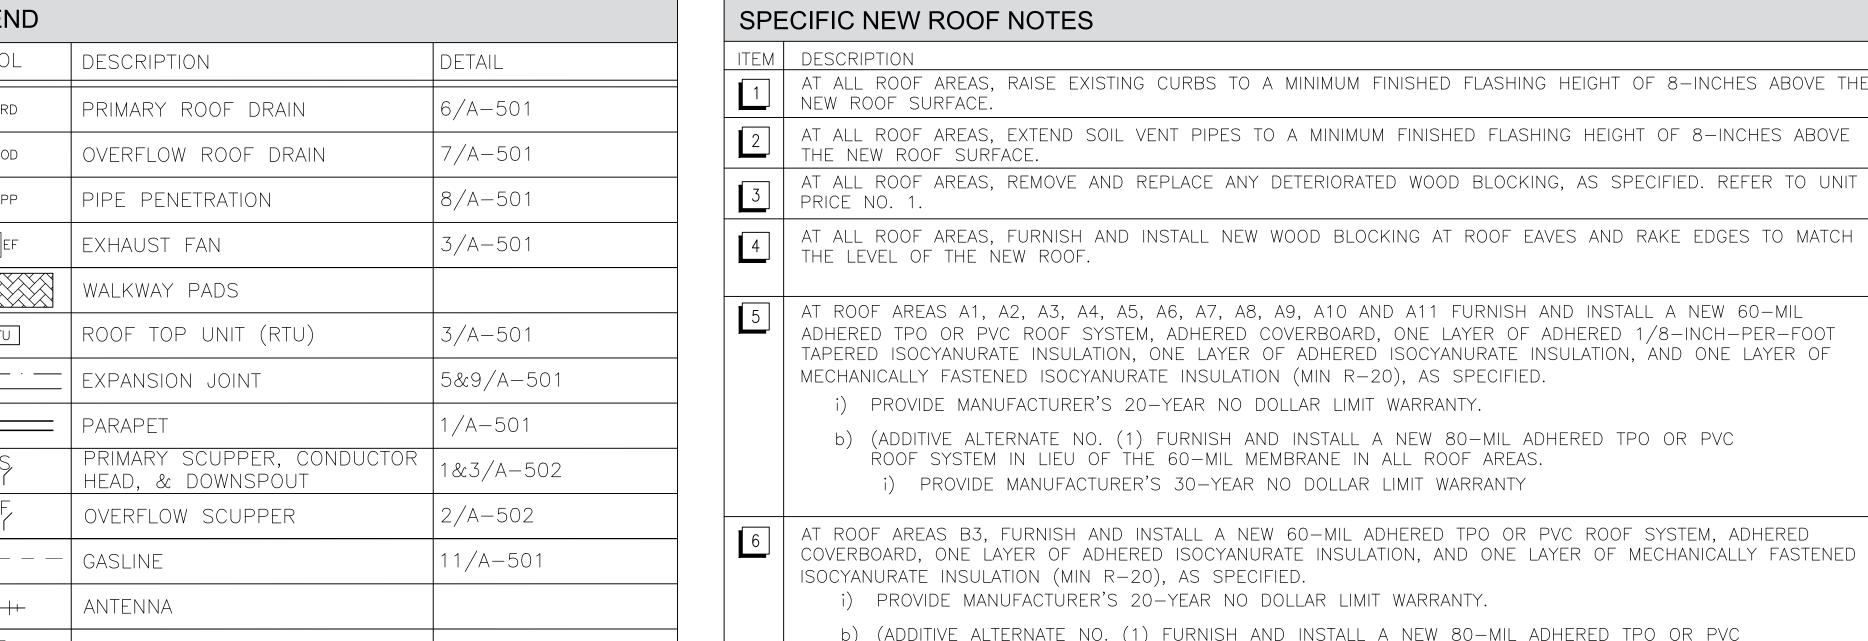




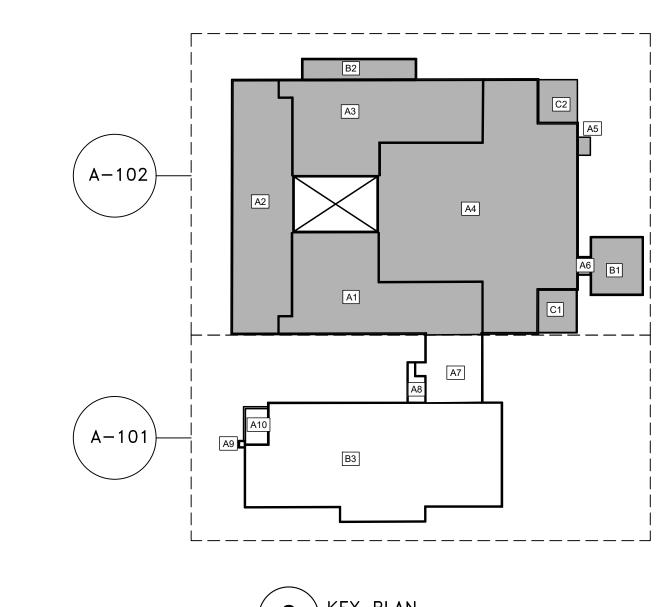
LEGEND		
SYMBOL	DESCRIPTION	DETAIL
⊠ RD	PRIMARY ROOF DRAIN	6/A-501
↔ od	OVERFLOW ROOF DRAIN	7/A-501
O PP	PIPE PENETRATION	8/A-501
EF	EXHAUST FAN	3/A-501
	WALKWAY PADS	
RTU	ROOF TOP UNIT (RTU)	3/A-501
	EXPANSION JOINT	5&9/A-501
	PARAPET	1/A-501
P\$	PRIMARY SCUPPER, CONDUCTOR HEAD, & DOWNSPOUT	1&3/A-502
QF,	OVERFLOW SCUPPER	2/A-502
	GASLINE	11/A-501
-+ - -	ANTENNA	
	ABOVE ROOF DOOR	

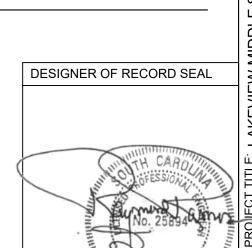
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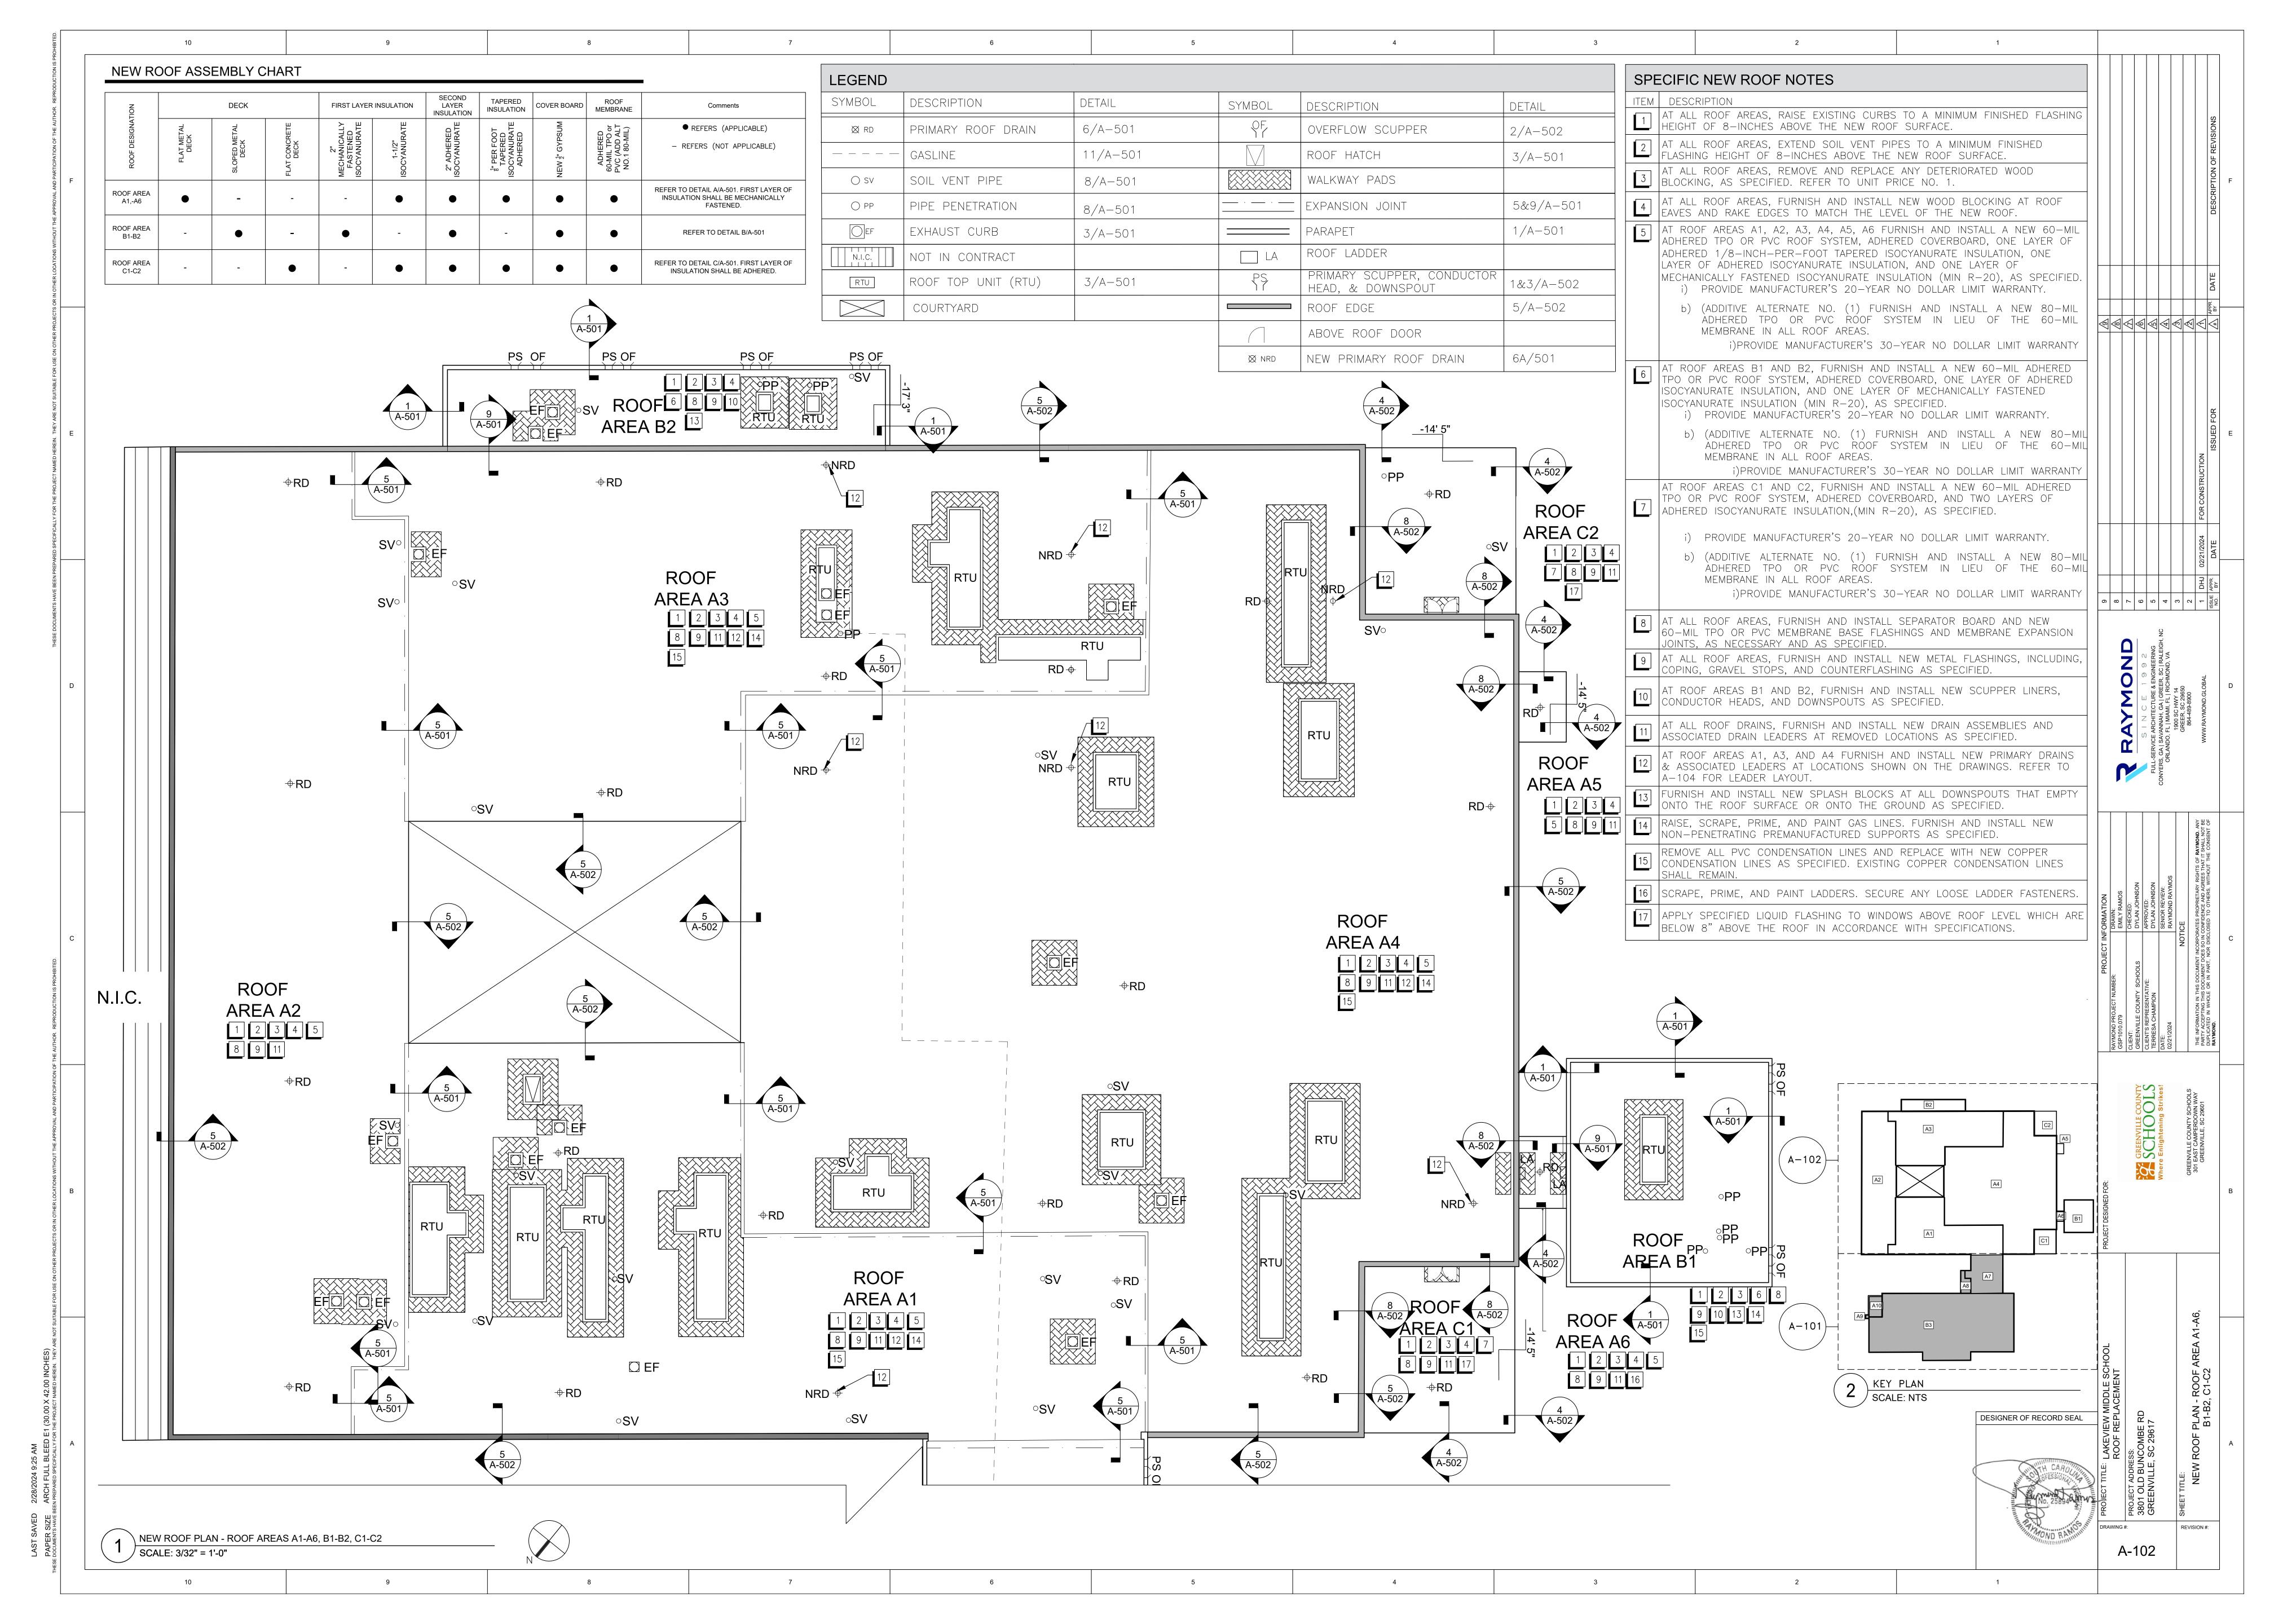


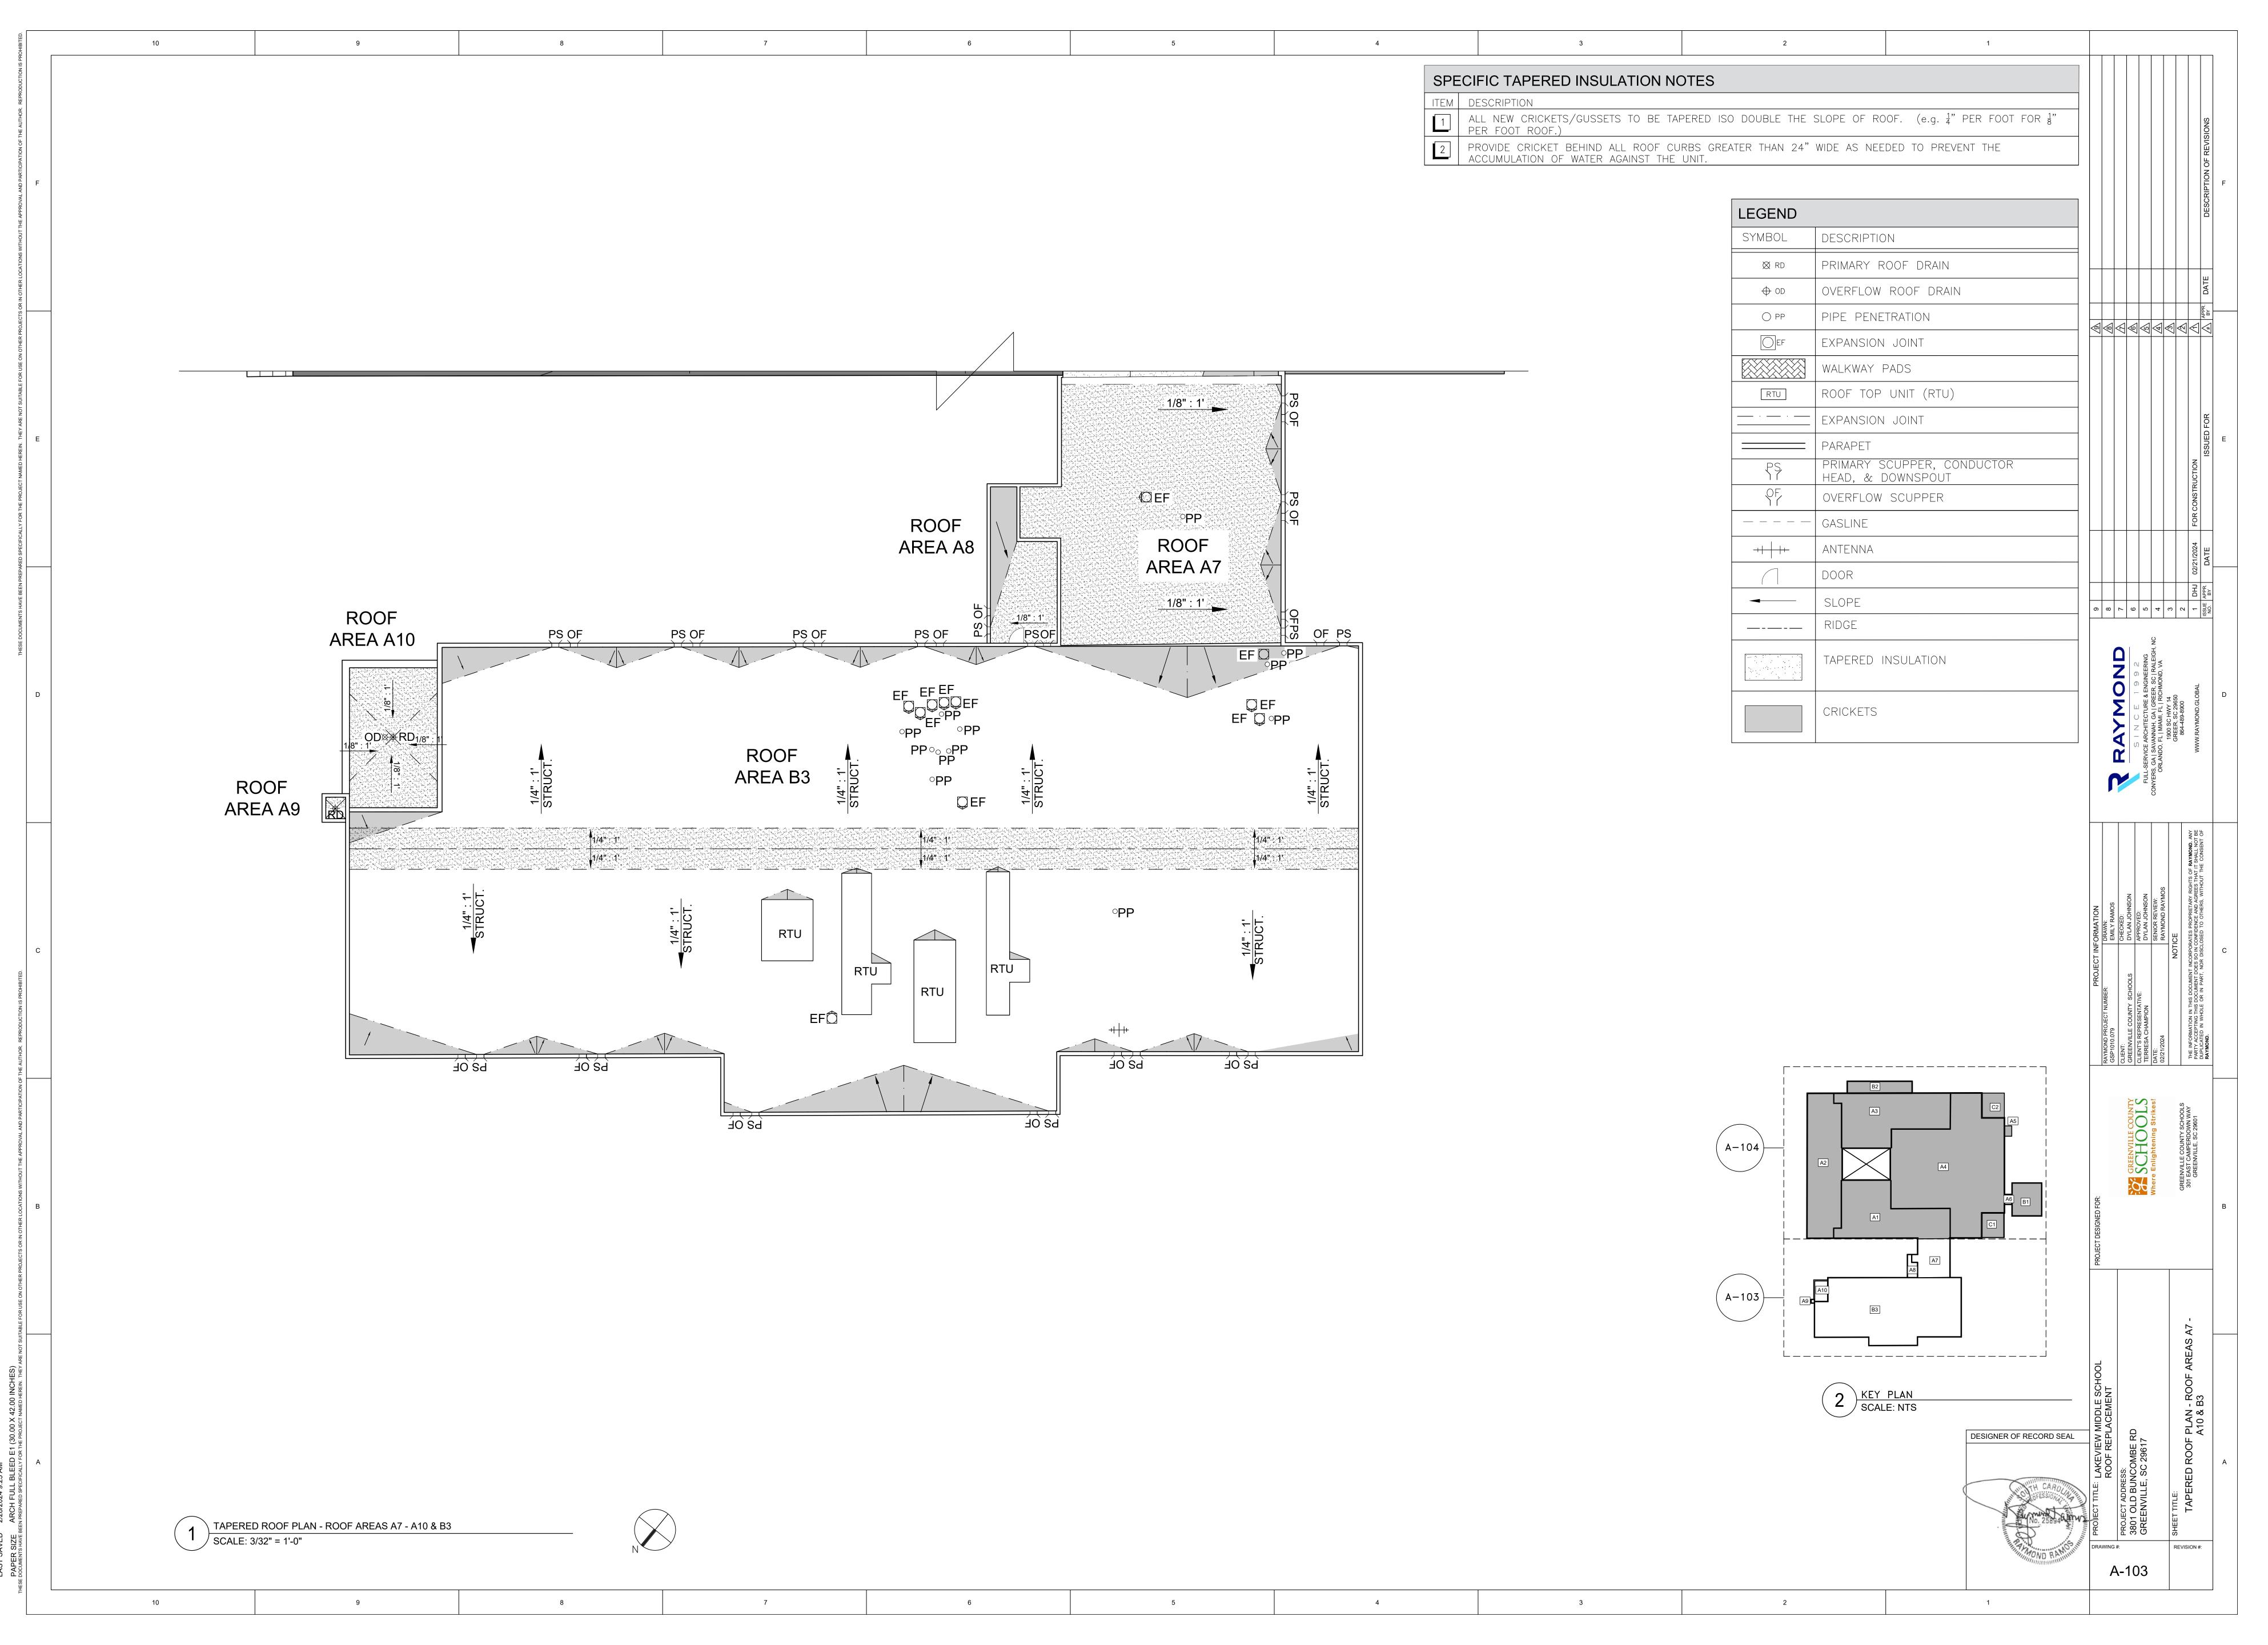


SCHOOLS SCHOOLS

NEW ROOF PLAN - ROOF AREAS A7 - A10 & B3

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