PARK PLACE ON PEACHTREE

2660 Peachtree Road NW, Atlanta, Georgia 30305


CLIENT:

Park Place on Peachtree Condominium Association

2660 Peachtree Road NW Atlanta, Georgia 30305

OWNER'S REPRESENTATIVE
Vandermeer Management, LLC
309 Sycamore Street, Suite F
Duluth, Georgia 30030
404.556.7835 tel

PLAZA WATERPROOFING, HARDSCAPE, AND LANDSCAPE DEVELOPMENT - PHASE I

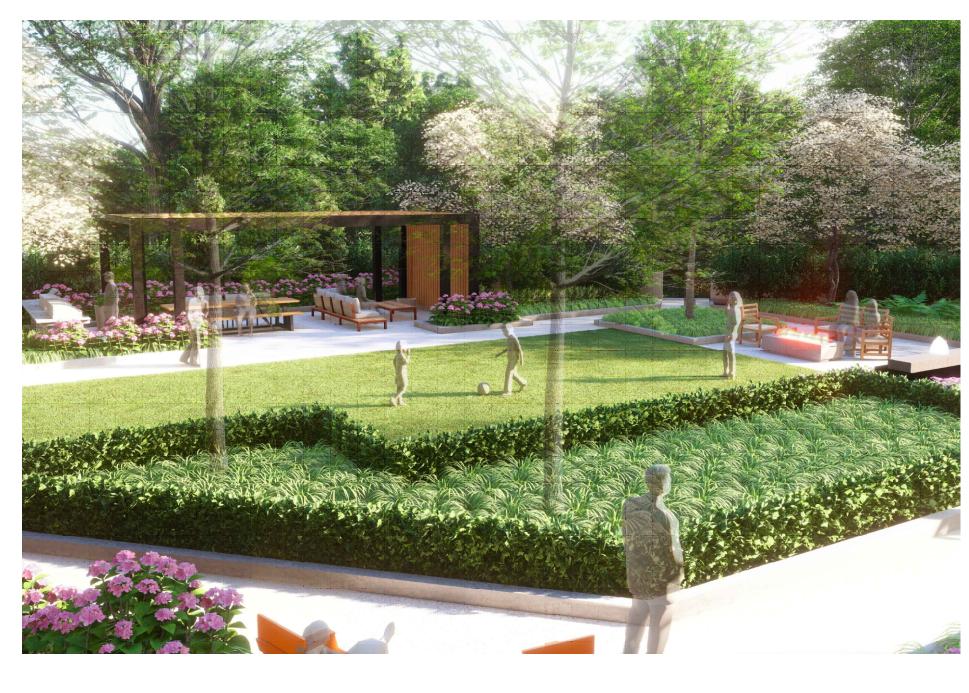



DESIGN PROFESSIONALS OF RECORD

WATERPROOFING ARCHITECT:

Wiss, Janney, Elstner Associates, Inc. 2055 Sugarloaf Circle, Suite 250 Duluth, Georgia 30097 770.923.9822 tel | 770.232.9044 fax

LANDSCAPE ARCHITECT:

HGOR 3525 Piedmont Road NEW, Bldg. 8, Suite 320 Atlanta, Georgia 30305 404.248.1960 tel

APPLICABLE CODES AND STANDARDS:

ALL WORK SHALL BE IN ACCORDANCE WITH THE CURRENT BUILDING CODE FOR ATLANTA, GOERIGA. THE PUBLICATIONS LISTED BELOW ARE THE COVERING CODES AND STANDARDS AND ARE REFERENCED BY THE BASIC DESIGNATION. IN THE CASE OF CONFLICTING REQUIREMENTS, THE BUILDING CODE SHALL GOVERN THE STRUCTURAL CLASSIFICATION OF WORK IS ALTERATION LEVEL 2.

AISC AMERICAN INSTITUTE OF STEEL CONSTRUCTION, SPECIFICATION FOR STRUCTURAL STEEL BUILDINGS (AISC 360-16)

ASCE AMERICAN SOCIETY OF CIVIL ENGINEERS, MINIMUM DESIGN LOADS FOR BUILDINGS AND OTHER STRUCTURES (ASCE 7-16)

ASTM AMERICAN SOCIETY FOR TESTING AND MATERIALS

AWS AMERICAN WELDING SOCIETY, 2015 STRUCTURAL WELDING CODE - STEEL (AWS D1.1)

BUILDING CODE INTERNATIONAL BUILDING CODE, 2018 EDITION, WITH GEORGIA STATE AMENDMENTS

OSHA OCCUPATIONAL SAFETY AND HEALTH ACT

NRCA NATIONAL ROOFING CONTRACTORS ASSOCIATION - NRCA WATERPROOFING MANUAL

SMACNA SHEET METAL AND AIR CONDITIONING CONTRACTORS NATIONAL ASSOCIATION, INC. -

PROJECT DESCRIPTION:

ARCHITECTURAL SHEET METAL MANUAL

PLAZA WATERPROOFING - WJE CONSTRUCTION DOCUMENTS

- THE EXISTING PLAZA ASSEMBLY, PLANTERS, CONCRETE TOPPINGS, WATERPROOFING MEMBRANE, AND OTHER OVERBURDEN MATERIALS WILL BE REMOVED DOWN TO THE EXISTING CONCRETE POST TENSIONED STRUCTURAL SLAB.
 THE EXISTING GRAVITY LOADS ON THE STRUCTURAL PLAZA DECK ARE NOT TO BE INCREASED BEYOND THE ORIGINAL DESIGN LOADS FOR THE STRUCTURAL SLAB PER SECTION 3404.3 OF THE BUILDING CODE. REFER TO R4.0 AND R4.1 FOR LOAD ANALYSIS.
 A NEW WATERPROOFING MEMBRANE WILL BE INSTALLED TO THE PREPARED STRUCTURAL SLAB AND PLANTER AREAS, WITH NEW DRAINS.
- NEW AREA DRAINS, GAS, WATER, AND ELECTRICAL CONDUIT PENETRATIONS ARE TO BE WATERPROOFED. REFER TO HGOR HARDSCAPE AND LANDSCAPE DEVELOPMENT DRAWINGS FOR LOCATIONS.
 NEW OVERBURDEN MATERIALS CONSISTING OF ASPHALT PAVING, PAVERS, PLANTERS, LANDSCAPING MATERIALS, IRRIGATION, LIGHTING, ELECTRICAL, PLUMBING, AND OTHER AMENITY
- NEW OVERBURDEN MATERIALS CONSISTING OF ASPHALT PAVING, PAVERS, PLANTERS, LANDSCAPING MATERIALS, IRRIGATION, LIGHTING, ELECTRICAL, PLUMBING, AND OTHER AMENITY STRUCTURES WILL BE ADDED OVER THE PREPARED AND WATERPROOFED STRUCTURAL SLAB DESIGNED BY OTHERS. REFER TO HGOR HARDSCAPE AND LANDSCAPE DEVELOPMENT DRAWINGS FOR ALL OVERBURDEN MATERIALS, LOCATIONS, AND PLACEMENT.

INDEX OF DRAWINGS:

SHEET NUMBER	TITLE	RESPONSIBILITY
		WJE
R0.0	PROJECT INFORMATION	• • • •
R1.0	PLAZA LEVEL - DEMOLITION PLAN	WJE
R1.1	WATERPROOFING PLAN	WJE
R1.2	DRAIN AND OVERBURDEN PLAN	WJE
R1.3	UPPER PARKING LEVEL - RCP	WJE
R1.4	CONCRETE CONSTRUCTION & CONTROL JOINT PLAN	WJE
R2.0	PLAZA SECTIONS	WJE
R3.0	REPAIR DETAILS	WJE
R3.1	REPAIR DETAILS	WJE
R3.2	TYPICAL DETAILS	WJE
R3.3	CONCRETE PAVEMENT DETAILS	WJE
R3.4	CONCRETE PAVEMENT DETAILS	WJE
R4.0	PLAZA LEVEL NEW LOADING PLAN	WJE
R4.1	PLAZA LEVEL EXISTING LOADING PLAN	WJE
C-01	SITE DEMOLITION AND REMOVAL PLAN	HGOR / BREEDLOVE
C-02	OVERALL SITE PLAN	HGOR / BREEDLOVE
C-03	FIRE SITE PLAN	HGOR / BREEDLOVE
C-04		HGOR / BREEDLOVE
C-05	STORM DRAINAGE PLAN	HGOR / BREEDLOVE
	ES&PC PLAN - INITIAL PLAN PHASE	
C-06	ES&PC PLAN INTERMEDIATE PHASE	HGOR / BREEDLOVE
C-07	SITE UTILITY PLAN	HGOR / BREEDLOVE
C-08	SITE WORK CONSTRUCTION DETAILS	HGOR / BREEDLOVE
TP-01	TREE PROTECTION AND REMOVAL PLAN	HGOR
TP-02	TREE REPLACEMENT PLAN	HGOR
TP-03	TREE PROTECTION DETAILS AND RECOMPENSE CALCULATIONS	HGOR
HS-01		HGOR
HS-02	NOTES AND ABBREVIATIONS	HGOR
	SHEET KEY	
HS-03	HARDSCAPE IMPROVEMENTS AND LIGHTING PLAN - ENTRANCE PLAZA	HGOR
HS-04	GRADING AND DRAINAGE AND LAYOUT PLAN - ENTRANCE PLAZA	HGOR
HS-05	HARDSCAPE IMPROVEMENTS AND LIGHTING PLAN - NORTH PARKING	HGOR
HS-06	GRADING AND DRAINAGE AND LAYOUT PLAN - NORTH PARKING	HGOR
HS-07	HARDSCAPE IMPROVEMENTS AND LIGHTING PLAN - POOL AREA	HGOR
HS-08	GRADING AND DRAINAGE AND LAYOUT PLAN - POOL AREA	HGOR
HS-09	HARDSCAPE IMPROVEMENTS AND LIGHTING PLAN - SOUTH GARDEN	HGOR
HS-10		HGOR
HS-11	GRADING AND DRAINAGE AND LAYOUT PLAN - SOUTH GARDEN	HGOR
	HARDSCAPE IMPROVEMENTS AND LIGHTING PLAN - SOUTH PARKING	
HS-12	GRADING AND DRAINAGE AND LAYOUT PLAN - SOUTH PARKING	HGOR
HS-13	NOT IN SET	HGOR
HS-14	NOT IN SET	HGOR
HS-18	HARDSCAPE DETAILS	HGOR
HS-19	HARDSCAPE DETAILS	HGOR
HS-20	HARDSCAPE DETAILS	HGOR
HS-21	HARDSCAPE DETAILS	HGOR
HS-22		HGOR
HS-23	HARDSCAPE DETAILS	HGOR
	HARDSCAPE DETAILS	
HS-24	HARDSCAPE DETAILS	HGOR
HS-25	HARDSCAPE DETAILS	HGOR
HS-26	HARDSCAPE DETAILS	HGOR
HS-27	HARDSCAPE DETAILS	HGOR
LS-01	LANDSCAPE DEVELOPMENT PLAN	HGOR
LS-02	LANDSCAPE DEVELOPMENT PLAN	HGOR
LS-03	LANDSCAPE DEVELOPMENT PLAN	HGOR
LS-04	LANDSCAPE DEVELOPMENT PLAN	HGOR
LS-05	LANDSCAPE DEVELOPMENT PLAN	HGOR
LS-06		HGOR
LS-07	LANDSCAPE DETAILS	
	LANDSCAPE DETAILS	HGOR
LS-08	LANDSCAPE DETAILS SCHEDULES	HGOR
IR-01	IRRIGATION LIMITS PLAN	HGOR
E000	LEGEND, SCHEDULES, & DETAILS - ELECTRICAL	HGOR / NBP ENGINEERS
E001	DETAILS ELECTRICAL	HGOR / NBP ENGINEERS
E100	SITE PLAN - DEMOLITION - ELECTRICAL	HGOR / NBP ENGINEERS
E200	SITE PLAN - NEW WORK - ELECTRICAL	HGOR / NBP ENGINEERS
E201	PORTE COCHERE PLAN - NEW WORK ELECTRICAL	HGOR / NBP ENGINEERS
E202		HGOR / NBP ENGINEERS
E203	PORTE COCHERE ROOF PLAN - NEW WORK - ELECTRICAL	HGOR / NBP ENGINEERS
	PARTIAL SITE PLAN - NEW WORK - ELECTRICAL	HOOK INDI LINGINLERG
D004		LICOD / NDD ENGINEERS
P001	LEGEND, SCHEDULES & DETAILS - PLUMBING	HGOR / NBP ENGINEERS
P100	UPPER PARKING LEVEL - DEMOLITION - PLUMBING	HGOR / NBP ENGINEERS
P101	PORTE COCHERE PLAN - DEMOLITION PLUMBING	HGOR / NBP ENGINEERS
P200	UPPER PARKING LEVEL - NEW WORK - PLUMBING	HGOR / NBP ENGINEERS
P201	SITE WORK - NEW WORK - PLUMBING	HGOR / NBP ENGINEERS
P202	PORTE COCHERE ROOF PLAN - NEW WORK - PLUMBING	HGOR / NBP ENGINEERS
	The state of the s	
S-1	CANOPY PLANS & DETAILS	HGOR / SE
	CAROLLI LARO & DETAILO	· · ·

PORTE COCHERE REPLACEMENT - PHASE II



DESIGN PROFESSIONALS OF RECORD

STRUCTURAL ENGINEER:

Wiss, Janney, Elstner Associates, Inc. 2055 Sugarloaf Circle, Suite 250 Duluth, Georgia 30097 770.923.9822 tel | 770.232.9044 fax

PORTE COCHERE ARCHITECT:

SMITH DALIA ARCHITECTS, LLC 83 Popular Street NW Atlanta, Georgia 30303 404.892.2443 tel

APPLICABLE CODES AND STANDARDS:

GEORGIA STATE MINIMUM STANDARD BUILDING CODE,

IBC 2018 INTERNATIONAL BUILDING CODE WITH GEORGIA STATE AMENDMENTS, 2020, 2022

IEBC 2018 INTERNATIONAL EXISTING BUILDING CODE WITH GEORGIA STATE AMENDMENTS, JANUARY 2021

INTERNATIONAL FIRE CODE WITH 2020 GEORGIA STATE FIRE COMMISSIONER AMENDMENTS, 120-2

INTERNATIONAL FIRE CODE WITH 2020 GEORGIA STATE FIRE COMMISIONER AMENDMENTS, 120-3-3-.04

IMC 2018
INTERNATIONAL MECHANICAL CODE, WITH GEORGIA AMENDMENTS 2020
INTERNATIONAL PLUMBING CODE, WITH GEORGIA AMENDMENTS 2020, 2021

NEC 2020
INTERNATIONAL ELECTRICAL CODE WITH GEORGIA AMENDMENTS 2021
INTERNATIONAL ENERGY CONSERVATION CODE WITH GEORGIA STATE SUPPLEMENTS AND AMENDMENTS

NFPA (101) 2018 LIFE SAFETY CODE WITH 2020 GEORGIA STATE FIRE COMMISSIONER AMENDMENTS 120-3-3-.04 (72)
REFERENCE STANDARDS

AMERICANS WITH DISABILITIES ACT (ADA) - 2010 ADA STANDARDS FOR ACCESSIBLE DESIGN (ADAAG)

PROJECT DESCRIPTION:

PARK PLACE IS A FORTY-STORY, CONCRETE FRAMED BUILDING THAT WAS CONSTRUCTED IN THE EARLY 1980'S. THE BUILDING CONSISTS OF CONDOMINIUM UNITS ON THE UPPER FORTY FLOORS AND THREE LEVELS OF PARTIALLY BELOW-GRADE PARKING, WITH A PLAZA LEVEL TOPPING THE PARKING STRUCTURE. THE BUILDING IS PRIMARILY CLAD WITH PRECAST CONCRETE PANELS AND HAS ALUMINUM-FRAMED STOREFRONT SYSTEMS INSTALLED AT THE ENTRANCE TO THE BUILDING. THE PORTE COCHERE STRUCTURE IS CONNECTED TO THE STOREFRONT SYSTEMS AND IS SUPPORTED BY THE BUILDING TO THE WEST AND FOUR COLUMNS TO THE EAST, SPANNING OVER THE ELEVATED PLAZA. THE STRUCTURE OF THE PORTE CONCHERE MEASURES APPROXIMATELY 48 FEET BY 30 FEET IN PLAN DIMENSIONS. THE EXISTING PORTE CONCHERE IS CLAD WITH STUCCO ON THE COLUMNS, FACES, AND SOFFIT, AND HAS A LOW-SLOPE ROOF ASSEMBLY WITH INTERIOR DRAINS.

THE PROJECT SCOPE CONSISTS OF A NEW PORTE COCHERE TO REPLACE THE ORIGINAL 1980'S ERA CONSTRUCTION, WITH THE INTENT TO UTILIZE THE EXISTING BELOW-GRADE STRUCTURE AS ITS SUPPORT AND MAINTAIN THE SAME APPROXIMATE FOOTPRINT. THE ORIGINAL SLANTED GLASS STOREFRONT WILL BE REMOVED AND REPLACED WITH A NEW STOREFRONT SYSTEM TO MATCH THE RECENTLY RENOVATED SLIDING GLASS ENTRY. THE SLIDING GLASS ENTRY WILL BE MAINTAINED TO SAVE COSTS. THE NEW PORTE COCHERE CONSTRUCTION CONSISTS OF A STEEL MOMENT FRAME WITH SUSPENDED METAL COMPOSITE PANEL.

DESIGN AND CONSTRUCTION OF THE NEW PORTE CONCHERE IS TO BE GENERALLY CONCURRENT WITH THE SITE REDEVELOPMENT AND PLAZA DECK WATERPROOFING PROJECTS BEING PERFORMED BY HGOR AND WJE, RESPECTIVELY.

INDEX OF DRAWINGS:

INDEX OF DRAWINGS:			
HEET NUMBER	TITLE	RESPONSIBILITY	
A000	COVER / SITE PLAN	SDA	
A001	GENERAL NOTES	SDA	
A020	DEMOLITION PLANS	SDA	
A100	PLANS	SDA	
A200	RCP	SDA	
A300	SECTIONS & ELEVATIONS	SDA	
A500	ENVELOPE DETAILS	SDA	
A501	PORTE COCHERE DETAILS	SDA	
A502	GLAZING DETAILS	SDA	
S0.0	PROJECT INFORMATION	WJE	
S0.1	PROJECT INFORMATION	WJE	
S0.2	SPECIAL INSPECTIONS	WJE	
S1.0	PORTE COCHERE FRAMING PLANS	WJE	
S2.0	STEEL FRAMING ELEVATIONS	WJE	
S2.1	STEEL FRAMING SECTIONS	WJE	
S3.0	STEEL FRAMING DETAILS	WJE	
S3.1	STEEL FRAMING DETAILS	WJE	
S4.0	CONCRETE DETAILS	WJE	
S4.1	CONCRETE DETAILS	WJE	
05.0		\A/ IF	

COLUMN BASEPLATE ANCHORAGE DETAILS

WJE

Wiss, Janney, Elstner Associates, Inc 2055 Sugarloaf Circle, Suite 250 Duluth, Georgia 30097 770.923.9822 tel | 770.232.9044 fax

Atlanta | Austin | Boston | Chicago | Cleveland | Dallas | Denver | Detro Doylestown | Honolulu | Houston | Indianapolis | London | Los Angele Milwaukee | Minneapolis | New Haven | Northbrook (HQ) | New York Pittsburgh | Philadelphia | Portland | Princeton | Raleigh | San Antonio San Diego | San Francisco | Seattle | South Florida | Washington, DC

Consultants





Park Place on Peachtree 2660 Peachtree Rd NE Atlanta, Georgia 30305

Park Place on Peachtree Condominium Association 2660 Peachtree Rd NE Atlanta, Georiga 30305

07/15/2024 ADDENDUM NO. 4R
06/28/2024 RFI 33
06/19/2024 ADDENDUM NO. 4
05/01/2024 ADDENDUM NO. 3
03/01/2024 ADDENDUM NO. 2
02/12/2024 PERMIT REVISION
01/08/2024 ADDENDUM NO. 1
11/10/2023 ISSUED FOR CONSTRUCTION

THIS SHEET PLOTS FULL SIZE AT 30x42 (INCHES)

Project No. 2020.7251.1

Date 05/01/2024

Drawn RC/EG/RRK
Checked CG

Scale As Noted

Cover Shoo

G0.0

PARK PLACE ON PEACHTREE

PLAZA WATERPROOFING SCOPE

2660 PEACHTREE ROAD NE ATLANTA, GEORGIA 30305

WJE PROJECT NO. 2020.7251.1

INDEX TO DRAWINGS:

- G0.0 COVER SHEET PROJECT INFORMATION
- PLAZA LEVEL DEMOLITION PLAN WATERPROOFING PLAN
- DRAIN AND OVERBURDEN PLAN
- UPPER PARKING LEVEL RCP
- CONCRETE CONSTRUCTION & CONTROL JOINT PLAN
- PLAZA SECTIONS
- REPAIR DETAILS
- REPAIR DETAILS TYPICAL DETAILS
- CONTROL JOINT DETAILS
- PLAZA LEVEL NEW LOADING PLAN

APPLICABLE CODES AND STANDARDS:

ALL WORK SHALL BE IN ACCORDANCE WITH THE CURRENT BUILDING CODE FOR ATLANTA, GEORGIA. THE PUBLICATIONS LISTED BELOW ARE THE GOVERNING CODES AND STANDARDS AND ARE REFERENCED BY THE BASIC DESIGNATION. IN THE CASE OF CONFLICTING REQUIREMENTS, THE BUILDING CODE SHALL GOVERN. THE STRUCTURAL CLASSIFICATION OF WORK IS ALTERATION LEVEL 2.

- AMERICAN INSTITUTE OF STEEL CONSTRUCTION, SPECIFICATION FOR STRUCTURAL STEEL BUILDINGS (AISC 360-16)
- **ASCE** AMERICAN SOCIETY OF CIVIL ENGINEERS, MINIMUM DESIGN LOADS FOR BUILDINGS AND OTHER STRUCTURES (ASCE 7-16)
- AMERICAN SOCIETY FOR TESTING AND MATERIALS ASTM
- AMERICAN WELDING SOCIETY, 2015 STRUCTURAL WELDING CODE STEEL (AWS D1.1)
- INTERNATIONAL BUILDING CODE. 2018 EDITION. WITH GEORGIA STATE AMENDMENTS


ARCHITECTURAL SHEET METAL MANUAL

- OCCUPATIONAL SAFETY AND HEALTH ACT
- NATIONAL ROOFING CONTRACTORS ASSOCIATION NRCA WATERPROOFING MANUAL SHEET METAL AND AIR CONDITIONING CONTRACTORS NATIONAL ASSOCIATION, INC.

ABBREVIATIONS:

ARCHITECT/ENGINEER ALT. ALTERNATE APPROX. **APPROXIMATELY** N.I.C. NOT IN SCOPE ON CENTER OPP. OPPOSITE SIMILAR S.I.A. SLOPE IN DECK STAINLESS STEEL TYP. TYPICAL


U.O.N. UNLESS OTHERWISE NOTED HRA HOT-RUBBERIZED ASPHALT RCP REFLECTED CEILING PLAN SYMBOLS:

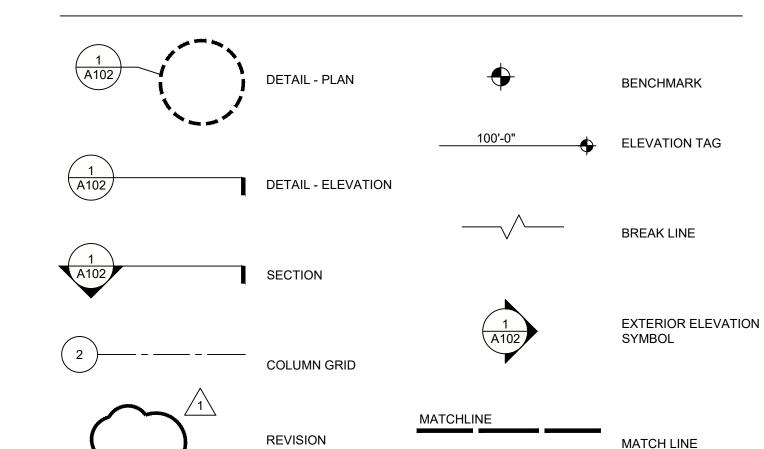

PROPERTY LINE / EXTENT

OF WORK AREA

PROJECT LOCATION:

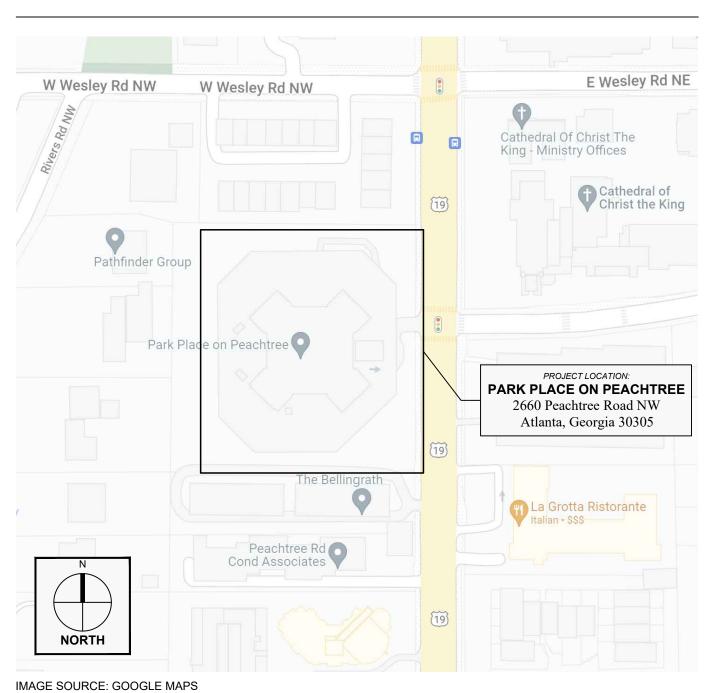

GENERAL NOTES:

- CONTRACTOR SHALL VERIFY ALL DIMENSIONS AND CONDITIONS IN FIELD. DO NOT SCALE DRAWINGS. DIMENSIONS SHOWN ON THE DRAWINGS ARE TAKEN FROM THE ORIGINAL CONSTRUCTION DOCUMENTS AND ARE PROVIDED FOR INFORMATION ONLY.
- CONTRACTOR SHALL VERIFY ALL QUANTITIES. QUANTITIES SHOWN ARE FOR ESTIMATING PURPOSES ONLY. ALLOWANCE QUANTITIES ARE ESTIMATED FROM A VISUAL SURVEY ONLY.
- 3. THE CONTRACTOR SHALL COORDINATE REQUIREMENTS AND PROVIDE PROOF OF INSURANCE PRIOR TO THE
- THERE SHALL BE COMPLETE COOPERATION BETWEEN THE GENERAL CONTRACTOR AND SUB-CONTRACTORS TO ENSURE SATISFACTORY PROGRESS AND PERFORMANCE OF THE WORK.
- THE CONTRACTOR SHALL VERIFY EXISTING PLUMBING AND ELECTRICAL LINES AND EQUIPMENT THAT WILL BE ACCESSED AS PART OF WORK PERFORMED. THE CONTRACTOR SHALL PROVIDE ALL NECESSARY EQUIPMENT. LABOR, MATERIALS, AND COMPONENTS REQUIRED FOR THE TEMPORARY RELOCATION OF MECHANICAL/ELECTRICAL EQUIPMENT AND PLUMBING LINES DURING THE REPAIR WORK.
- 6. THE CONTRACTOR SHALL SECURE AND PAY FOR ALL PERMITS, LICENSES AND GOVERNMENT FEES AS REQUIRED. THE CONTRACTOR SHALL COMPLY WITH CODES, ORDINANCES, RULES, REGULATIONS, ORDERS AND

OTHER LEGAL REQUIREMENTS OF PUBLIC AUTHORITY, WHICH BEAR ON THE PERFORMANCE OF THE WORK.

- CONTRACTOR SHALL PROMPTLY SUBMIT VERBAL AND WRITTEN NOTICE TO THE ARCHITECT/ENGINEER OF OBSERVED VARIANCE OF THE CONTRACT DOCUMENTS FROM ACTUAL ON-SITE CONDITIONS.
- CONTRACTOR SHALL SUPPLY THE OWNER WITH MATERIAL SAFETY DATA SHEETS (MSDS) FOR EACH CHEMICAL THAT WILL BE BROUGHT ONTO THE JOB SITE AND SHALL COMPLY WITH THE REQUIREMENTS OF THE OSHA HAZARD COMMUNICATION STANDARD
- 9. THE CONTRACTOR MUST SUBMIT DEMOLITION AND CONSTRUCTION SCHEDULES TO THE OWNER AND ARCHITECT/ENGINEER FOR APPROVAL PRIOR TO BEGINNING DEMOLITION
- THE PRODUCTS SPECIFIED ARE BELIEVED TO HAVE PROPERTIES ADEQUATE FOR SUCCESSFUL COMPLETION OF THE WORK. IF THE CONTRACTOR HAS FOUND THESE PRODUCTS TO BE UNACCEPTABLE OR HAS HAD DIFFICULTY USING THESE MATERIALS, THE CONTRACTOR SHALL IMMEDIATELY INFORM THE
- 11. CONTRACTOR IS RESPONSIBLE FOR MEANS AND METHODS OF THE REPAIR WORK
- WISS, JANNEY, ELSTNER ASSOCIATES, INC. (WJE) SHALL NOT HAVE CONTROL OVER OR CHARGE OF AND SHALL NOT BE RESPONSIBLE FOR CONSTRUCTION MEANS, METHODS, TECHNIQUES, SEQUENCES OR PROCEDURES. OR FOR SAFETY PRECAUTIONS AND SAFETY PROGRAMS IN CONNECTION WITH THE PROJECT. SINCE THESE ARE THE RESPONSIBILITY OF OTHERS, WJE SHALL NOT BE RESPONSIBLE FOR THE CONTRACTOR'S SCHEDULES OR FAILURE TO CARRY OUT THE PROJECT IN ACCORDANCE WITH CONTRACT DOCUMENTS. WJE SHALL NOT HAVE CONTROL OVER OR CHARGE OF ACTS OR OMISSIONS OF THE CONTRACTOR, SUBCONTRACTORS, OR THEIR AGENTS OR EMPLOYEES, OR OF ANY OTHER NON-WJE PERSONS PERFORMING PORTIONS OF THE
- 13. THE CONTRACTOR WILL LIMIT ON-SITE STORAGE OF MATERIALS TO THOSE AREAS IDENTIFIED BY THE OWNER. THE CONTRACTOR SHALL NOT UNREASONABLY ENCUMBER SITE WITH MATERIALS OR EQUIPMENT. THE MATERIALS AND EQUIPMENT SHALL BE CONFINED TO THE AREAS INDICATED IN THE CONTRACT DOCUMENTS OR BY THE DIRECTION OF THE OWNER OR ARCHITECT/ENGINEER. DO NOT LOAD STRUCTURE WITH WEIGHT THAT WILL ENDANGER STRUCTURE. CONTRACTOR SHALL ASSUME FULL RESPONSIBILITY FOR THE PROTECTION AND SAFEKEEPING OF PRODUCTS STORED ON PREMISES. CONTRACTOR SHALL MOVE ANY STORED MATERIAL OR PRODUCTS WHICH INTERFERE WITH OPERATIONS OF THE OWNER.
- 14. WATER AND ELECTRICITY MAY BE TAKEN FROM BUILDING FOR CONSTRUCTION PURPOSES ONLY AT AREAS IDENTIFIED ACCEPTABLE BY THE OWNER. TOILET FACILITIES IN BUILDING SHALL NOT BE USED BY THE
- 15. CONTRACTOR SHALL PROVIDE AND MAINTAIN REQUIRED DUST BARRIERS, CANOPIES, BARRICADES, PROTECTION AND WARNING LIGHTS IN GOOD CONDITION UNTIL THE COMPLETION OF THE WORK REQUIRING SUCH PROTECTION AND THEN REMOVE THE SAME. ALL CANOPIES AND BARRICADES SHALL COMPLY WITH FEDERAL, STATE AND LOCAL LAWS AND REGULATIONS.
- 16. THE CONTRACTOR SHALL MAINTAIN PREMISES FREE FROM ACCUMULATIONS OF WASTE MATERIAL AND
- 17. THE CONTRACTOR IS TO RETURN DAMAGED AREAS TO ORIGINAL CONDITION. THE CONTRACTOR SHALL PROTECT GROUNDS AND LANDSCAPING WHEN PERFORMING WORK. THE CONTRACTOR WILL BE RESPONSIBLE FOR DAMAGE TO GROUNDS AND LANDSCAPING AND BE REQUIRED TO REPAIR OR REPLACE AS NECESSARY.
- 19. CONTRACTOR SHALL COMPLY WITH ALL SECURITY PROCEDURES REQUIRED BY THE OWNER.

- 20. COSTS CAUSED BY ILL-TIMED WORK, DEFECTIVE WORK OR WORK NOT CONFORMING TO THE CONTRACT DOCUMENTS, ARE THE RESPONSIBILITY OF THE CONTRACTOR.
- 21. THE CONTRACTOR SHALL PROVIDE SHORING, BRACING AND SUPPORT AS REQUIRED TO MAINTAIN THE STRUCTURAL INTEGRITY OF THE NEW OR EXISTING CONSTRUCTION DURING THE WORK. CONSTRUCTION DEBRIS SHALL BE REMOVED IN A MANNER THAT AVOIDS OVERLOADING ADJACENT STRUCTURAL MEMBERS.
- 22. THE CONTRACTOR AND HIS RESPECTIVE SUBCONTRACTORS SHALL EACH HAVE FIVE OR MORE YEARS EXPERIENCE PERFORMING REPAIR WORK SIMILAR IN SIZE, TYPE, AND COMPLEXITY TO WHAT IS SHOWN IN THE
- 23. ENFORCE STRICT DISCIPLINE AND GOOD ORDER AMONG EMPLOYEES. DO NOT EMPLOY UNFIT PERSONS OR PERSONS NOT SKILLED IN THE ASSIGNED TASK.
- 24. WHERE A DETAIL IS SHOWN FOR ONE CONDITION, IT SHALL APPLY FOR ALL LIKE OR SIMILAR CONDITIONS, EVEN THOUGH NOT SPECIFICALLY MARKED ON THE DRAWINGS.
- 25. ALL CONSTRUCTION SHALL BE SUBJECT TO REVIEW BY THE ARCHITECT/ENGINEER BEFORE IT IS CONCEALED FROM VIEW. COORDINATE EXPECTED REVIEW ITEMS WITH THE ARCHITECT/ENGINEER PRIOR TO THE START OF CONSTRUCTION AND PROVIDE REASONABLE NOTIFICATION TO THE ARCHITECT/ENGINEER TO ALLOW FOR SUCH
- REMOVE AND DISPOSE OF IN A PROPER MANNER (OFF-SITE) ALL EXISTING MATERIAL REMOVED FROM THE BUILDING DURING THE COURSE OF THE WORK ON A DAILY BASIS. REMOVAL AND DISPOSAL SHALL BE SATISFACTORY TO THE ARCHITECT/ENGINEER AND OWNER
- 27. CONTRACTOR SHALL COORDINATE USE OF PREMISES UNDER THE DIRECTION OF THE OWNER. TEMPORARY DISRUPTIONS TO THE USE OF THE BUILDING BY EMPLOYEES AND PUBLIC, INCLUDING NOISE, DUST AND DISRUPTION OF UTILITIES, SHALL BE COORDINATED A MINIUMUM OF 48 HOURS IN ADVANCE AND APPROVED BY THE OWNER. CONTRACTOR WORK NOT COORDINATED IN ADVANCE WHICH CAUSES DISRUPTIONS TO THE USE OF THE BUILIDNG BY EMPLOYEES AND PUBLIC MAY BE STOPPED BY THE OWNER AND SHALL NOT BE COMMENCED AGAIN UNTIL PROPER COORDINATION IS ACHIEVED. CONTRACTOR SHALL BE RESPONSIBLE FOR ALL COSTS RESULTING FROM WORK STOPPAGES OR DELAYS CAUSED BY CONTRACTORS LACK OF COORDINATION WITH THE OWNER.
- 28. CONTRACTOR SHALL BE RESPONSIBLE FOR MAINTAINING THE WATER TIGHTNESS OF THE AREAS OF THE STRUCTURE BEING WORKED ON DURING THE COURSE OF THE WORK. PROVIDE TEMPORARY PROTECTION OF THE EXISTING CONSTRUCTION FROM THE WEATHER UNTIL REMOVED PORTIONS ARE COMPLETELY REPLACE WITH NEW CONSTRUCTION. THE COST OF DAMAGE AND REPAIRS SHALL BE MADE AT NO COST TO THE OWNER.
- 29. THESE DRAWINGS AND SPECIFICATIONS APPLY TO THE PROJECT INDENTIFIED IN THE TITLEBLOCK ONLY AND SHALL NOT BE USED FOR ANY OTHER PURPOSE WITHOUT THE EXPRESSED WRITTEN CONSENT OF WJE.
- 30. IN THE EVENT OF CONFLICT BETWEEN THE DRAWINGS AND THE SPECIFICATIONS, THE MORE STRINGENT REQUIREMENT AND BETTER QUALITY SHALL GOVERN UNLESS WRITTEN NOTIFICATION IS PROVIDED BY THE
- 31. THE SCOPE OF WORK COVERED UNDER THIS PROJECT INCLUDES THE COST OF HOISTING, SCAFFOLD, PEDESTRIAN PROTECTION, STORAGE, DEMOLITION, DISPOSAL, CONCRETE WORK, MASONRY, CARPENTRY, LUMBER, MECHANICAL, ELECTRICAL, AND PLUMBING.
- 32. SAFETY IS THE RESPONSIBILITY OF THE CONTRACTOR, AND THE CONTRACTOR SHALL CONDUCT WORK IN FULL AND COMPLETE ACCORDANCE WITH FEDERAL, STATE, AND LOCAL STATUTES, LAWS, AND ORDINANCES, INCLUDING, BUT NOT LIMITED TO OSHA AND EPA.
- 33. THE EXISTING BUILDING MUST REMAIN IN OPERATION 100 PERCENT OF THE TIME. DEMOLITION REQUIRED SHALL PROCEED ONLY AT THE DIRECTION OF THE OWNER ACCORDING TO SCHEDULES AS MUTUALLY AGREED UPON. THE CONTRACTOR SHALL PROVIDE ALL TEMPORARY CONTROLS AS NECESSARY TO ALLOW FOR THE BUILDING
- 34. DO NOT STOCKPILE CONSTRUCTION MATERIAL IN A MANNER THAT WILL OVERLOAD OR EXCEED THE CAPACITY OF THE STRUCTURAL MEMBERS.

SCOPE OF WORK:

DEMOLITION OF EXISTING PLAZA

- 1. REMOVE EXISTING OVERBURDEN FROM PLAZA DECK TO EXPOSE UNDERLYING STRUCTURAL CONCRETE DECK AND PERIMETER CAST-IN-PLACE PLANTER WALLS. THIS INCLUDES REMOVAL OF EXISTING ASPHALT PAVING, CONCRETE
- TOPPING, PEDESTAL/PAVER SYSTEMS, PLANTER FILL MATERIAL, AND ANY UNDERLYING WATERPROOFING MATERIAL. 1.1. EXISTING ASSEMBLY THICKNESSES HAVE BEEN APPROXIMATED BASED ON ORIGINAL DRAWINGS AND
- EXISTING ASSEMBLY THICKNESSES VARY FROM THAT ILLUSTRATED/IDENTIFIED IN THESE DRAWINGS.
- PERIMETER CURBS ILLUSTRATED ON SHEET R1.0.
- 2.2. SELECT WATER LEAKAGE LOCATIONS HAVE BEEN IDENTIFIED WITHIN THE PRIVATE TERRACE AREA ON THE
- 3. REMOVAL OF OVERBURDEN AT SOUTHEAST CORNER OF PLAZA DECK TO INCLUDE REMOVAL OF APPROXIMATELY 18
- 4. DEMOLISH THE EXISTING FRONT ENTRANCE PORTE-COCHERE STRUCTURE IN ACCORDANCE WITH THE DEMOLITION PLAN PROVIDED BY THE PORTE-COCHERE DESIGNER.
- REMOVE EXISTING DRAINS FROM PLAZA DECK IN ACCORDANCE WITH DRAIN LEGEND PROVIDED ON SHEET R1.0. WHEN REMOVING EXISTING DRAIN BODIES, REVIEW EXISTING DRAIN ASSEMBLY ELEMENTS EMBEDDED IN SLAB WITH AOR (E.G. DRAIN BOWLS). EXISTING EMBEDDED ELEMENTS IN GOOD CONDITION TO REMAIN. REMOVE SEVERELY CORRODED EMBEDDED DRAIN ASSEMBLY ELEMENTS AND REPLACE TO MATCH EXISTING. REMOVE ASSOCIATED DRAIN PIPING IN GARAGE BELOW IN GENERAL ACCORDANCE WITH SHEET R1.3 WHERE EXISTING DRAIN ASSEMBLIES ARE PERMANENTLY REMOVED.
- 1.1. ED1 EXISTING DRAIN PENETRATION TO REMAIN BENEATH PEDESTAL PAVERS. INSTALL NEW CLAMPING RING
- 1.2. ED2 EXISTING DRAIN PENETRATION TO REMAIN WITHIN PLANTER. INSTALL NEW PLANTER DRAIN ASSEMBLY IN
- 1.3. ED3 EXISTING DRAIN PENETRATION TO REMAIN AT CONCRETE TOPPING SLAB LOCATION. INSTALL NEW DRAIN IN ACCORDANCE WITH DETAIL 16/R3.2.
- 1.4. ED4 EXISTING DRAIN ASSEMBLY WITHIN PRIVATE TERRACE AREA TO REMAIN.
- FILLED WITH CONCRETE PATCH MATERIAL.
- 1.7. TD EXISTING TRENCH DRAINS INSTALLED AT BASE OF PLANTER WALLS TO BE REMOVED. FILL TRENCH DRAIN
- 2. INSTALL NEW DRAIN AT NEW DRAIN PENETRATIONS IN ACCORDANCE WITH DRAIN LEGEND PROVIDED ON SHEET
- R1.1. INSTALL NEW ASSOCIATED PIPING IN GENERAL ACCORDANCE WITH SHEET R1.3.
- 2.1. ND1 INSTALL NEW DRAIN WITHIN ASPHALT PAVING AREA IN ACCORDANCE WITH DETAIL 2/R3.0.
- 2.3. ND3 INSTALL NEW DRAIN IN NEW CONCRETE TOPPING SLAB IN ACCORDANCE WITH DETAIL 16/R3.2.
- DECK. WATERPROOFING ASSEMBLY TO INCLUDE UNCURED NEOPRENE FLASHING AT PENETRATIONS AND TRANSITIONS AND A PROTECTION SHEET EMBEDDED IN HRA. ROOT BARRIER TO BE INCLUDED IN PROTECTION COURSE WITHIN PLANTERS. WHERE SPECIFIED INSTALL NEW DIMPLE-BOARD TYPE DRAINAGE MAT WITH INTEGRAL
- 1.1. EXISTING STRUCTURAL DRAWINGS INDICATE SLOPE IS PROVIDED IN STRUCTURE FROM BUILDING PERIMETER TO EXISTING DRAINS AT PERIMETER OF PLAZA DECK (ILLUSTRATED ON SHEET R1.1). EXISTING SLOPE TO BE
- 1.2. ADD SLOPED BONDED OVERLAY TO STRUCTURAL DECK AS NECESSARY TO PROVIDE SLOPE TO DRAINS.
- PENETRATIONS IN ACCORDANCE WITH MANUFACTURER'S INSTRUCTIONS AS ILLUSTRATED IN DETAIL 19/R3.2.
- 3. ENCAPSULATE ALL NEW STRUCTURAL ATTACHMENTS AT PLAZA DECK IN GENERAL ACCORDANCE WITH DETAILS
- ACCORDANCE WITH DETAIL 8/R3.2.

NEW OVERBURDEN TO BE INSTALLED AT LOCATIONS OF AND IN ACCORDANCE WITH LANDSCAPING/HARDSCAPE

NEW CONCRETE PAVEMENT SLAB CONSTRUCTION AND CONTROL JOINT PLAN INCLUDED ON SHEET R1.4.

- EXPLORATORY OPENINGS MADE DURING THE INVESTIGATION PHASE OF THIS PROJECT. NOTIFY A/E WHERE
- 2. SELECTIVE DEMOLITION OF EXISTING CONCRETE ELEMENTS INCLUDES SELECT CONCRETE PLANTER WALLS AND
- 2.1. AREAS MARKED AS "PRIVATE TERRACES" ON SHEET R1.0 ARE RESIDENT-OWNED SPACES NOT TO BE INCLUDED IN SCOPE. COORDINATE DEMOLITION OF EXISTING ASSEMBLIES TO STOP AT PERIMETER OF PRIVATE TERRACE AREAS. ANY WALLS/STRUCTURES ENCLOSING PRIVATE TERRACE AREAS TO REMAIN UNLESS OTHERWISE
- SOUTH SIDE OF THE BUILDING. SELECTIVE DEMOLITION TO INCLUDE REMOVAL OF THE EXISTING OVERBURDEN AS NECESSARY TO IDENTIFY THE SOURCE(S) OF THESE LEAKS FOR REPAIR. THIS SELECTIVE DEMOLITION MAY INCLUDE WATER TESTING BY WJE TO CONFIRM LEAKAGE PATHS. IF WATER TESTING IS REQUIRED WJE WILL COORDINATE WATER TESTING TO COINCIDE WITH SELECTIVE DEMOLITION TO REVIEW EXISTING CONDITIONS
- INCHES OF SOIL AT EXISTING SLAB DEPRESSION MEASURING APPROXIMATELY 22 FEET BY 110 FEET IN ORDER TO INSTALL NEW CONCRETE SLAB ASSEMBLY TO FILL THIS DEPRESSION. SEE DETAIL 6/R3.0.
- PLAZA DECK DRAINAGE

- 1.5. ED5 EXISTING DRAIN ASSEMBLY TO BE REMOVED AND DRAIN PENETRATION IN STRUCTURAL SLAB TO BE
- 1.6. CB EXISTING PARKING LOT DRAIN COLLECTION BOXES AT BASE OF PLANTERS TO BE REMOVED.
- AND DRAIN PENETRATION VOIDS IN STRUCTURAL SLAB WITH CONCRETE PATCH MATERIAL.
- 2.2. ND2 INSTALL NEW PLANTER DRAIN WITHIN NEW PLANTER AREA IN ACCORDANCE WITH DETAIL 9/R3.2.
- HOT-RUBBERIZED ASPHALT WATERPROOFING
- 1. INSTALL NEW FABRIC-REINFORCED HOT-RUBBERIZED ASPHALT (HRA) WATERPROOFING ASSEMBLY OVER THE PLAZA FILTER FABRIC OVER NEW WATERPROOFING ASSEMBLY. WHERE SPECIFIED INSTALL NEW CRUSHED GRAVEL OR EXTRUDED POLYSTYRENE (XPS) INSULATION BOARD OVER WATERPROOFING AND DRAINAGE ASSEMBLY
- CONFIRMED DURING DEMOLITION OF EXISTING OVERBURDEN.
- 2. ENSURE ALL STRUCTURAL DECK PENETRATIONS ARE SPACED A MINIMUM OF 4" APART TO ALLOW FOR FLASHING OF
- 4. ENSURE ALL NEW CONCRETE MEMBERS INTEGRATED WITH STRUCTURAL DECK ARE WATERPROOFED IN

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Park Place on Peachtree

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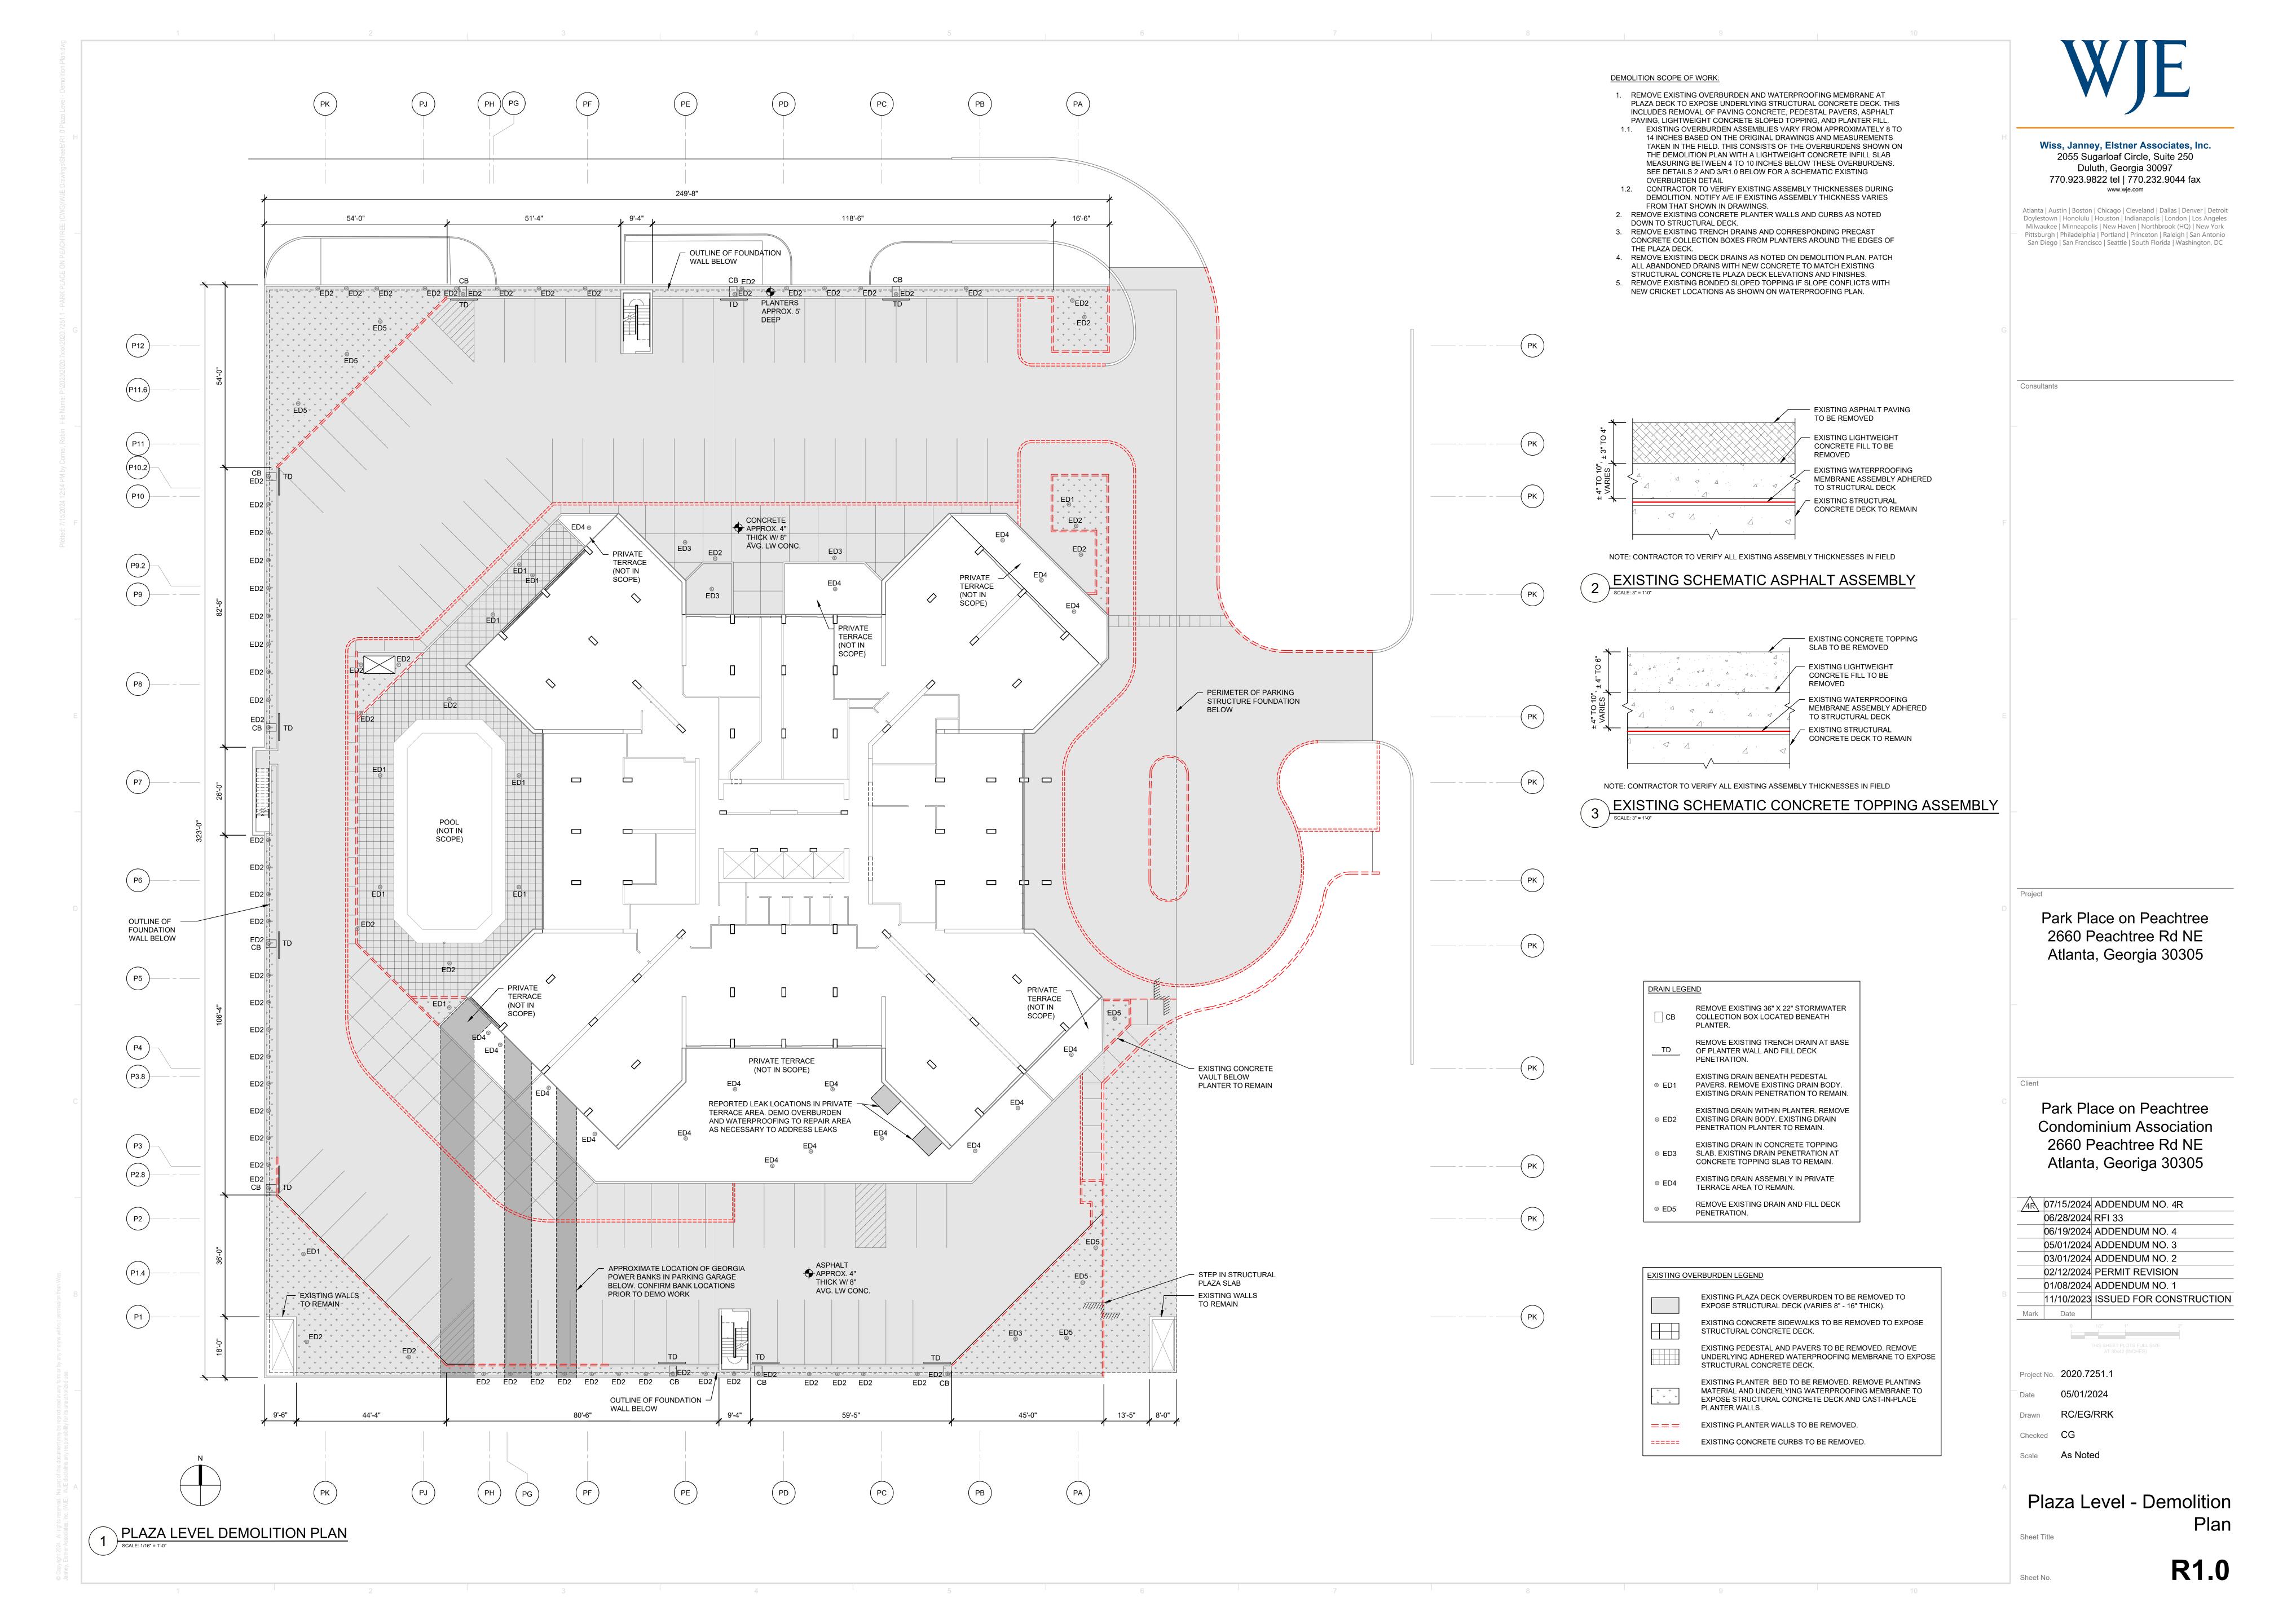
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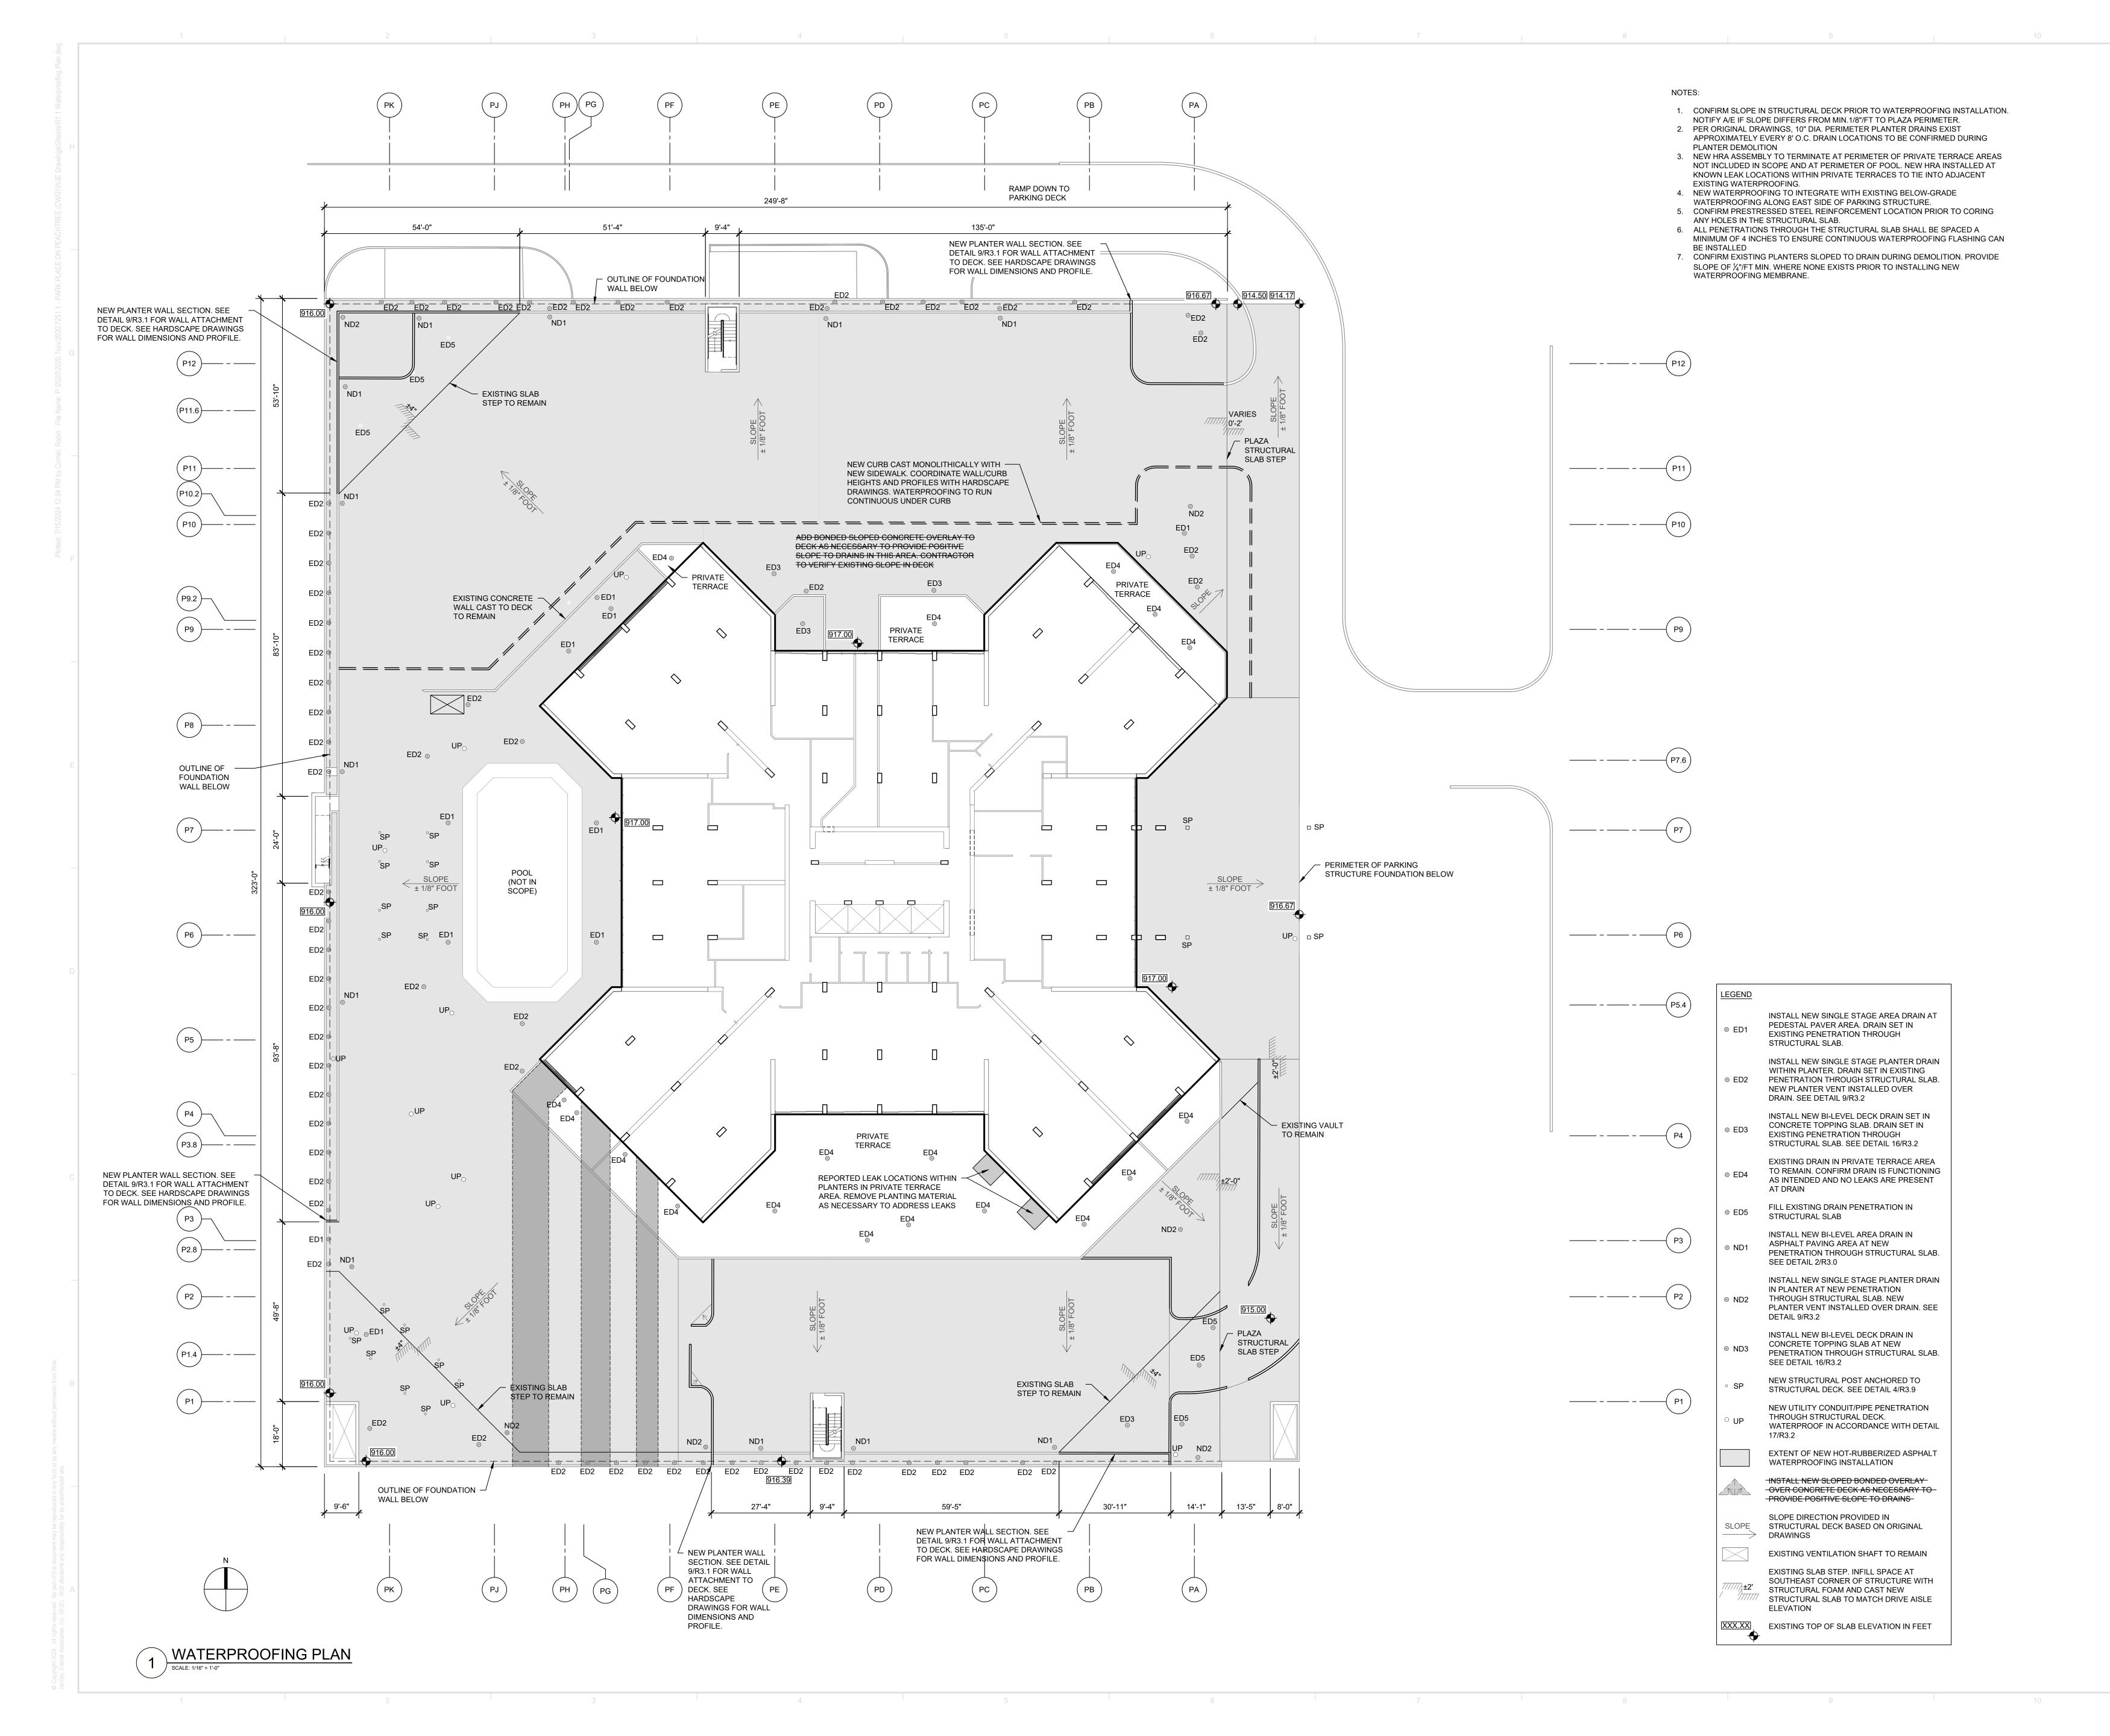
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Project Information







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THIS SHEET PLOTS I AT 30x42 (INCH

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 2020.7251.1

 Date
 05/01/2024

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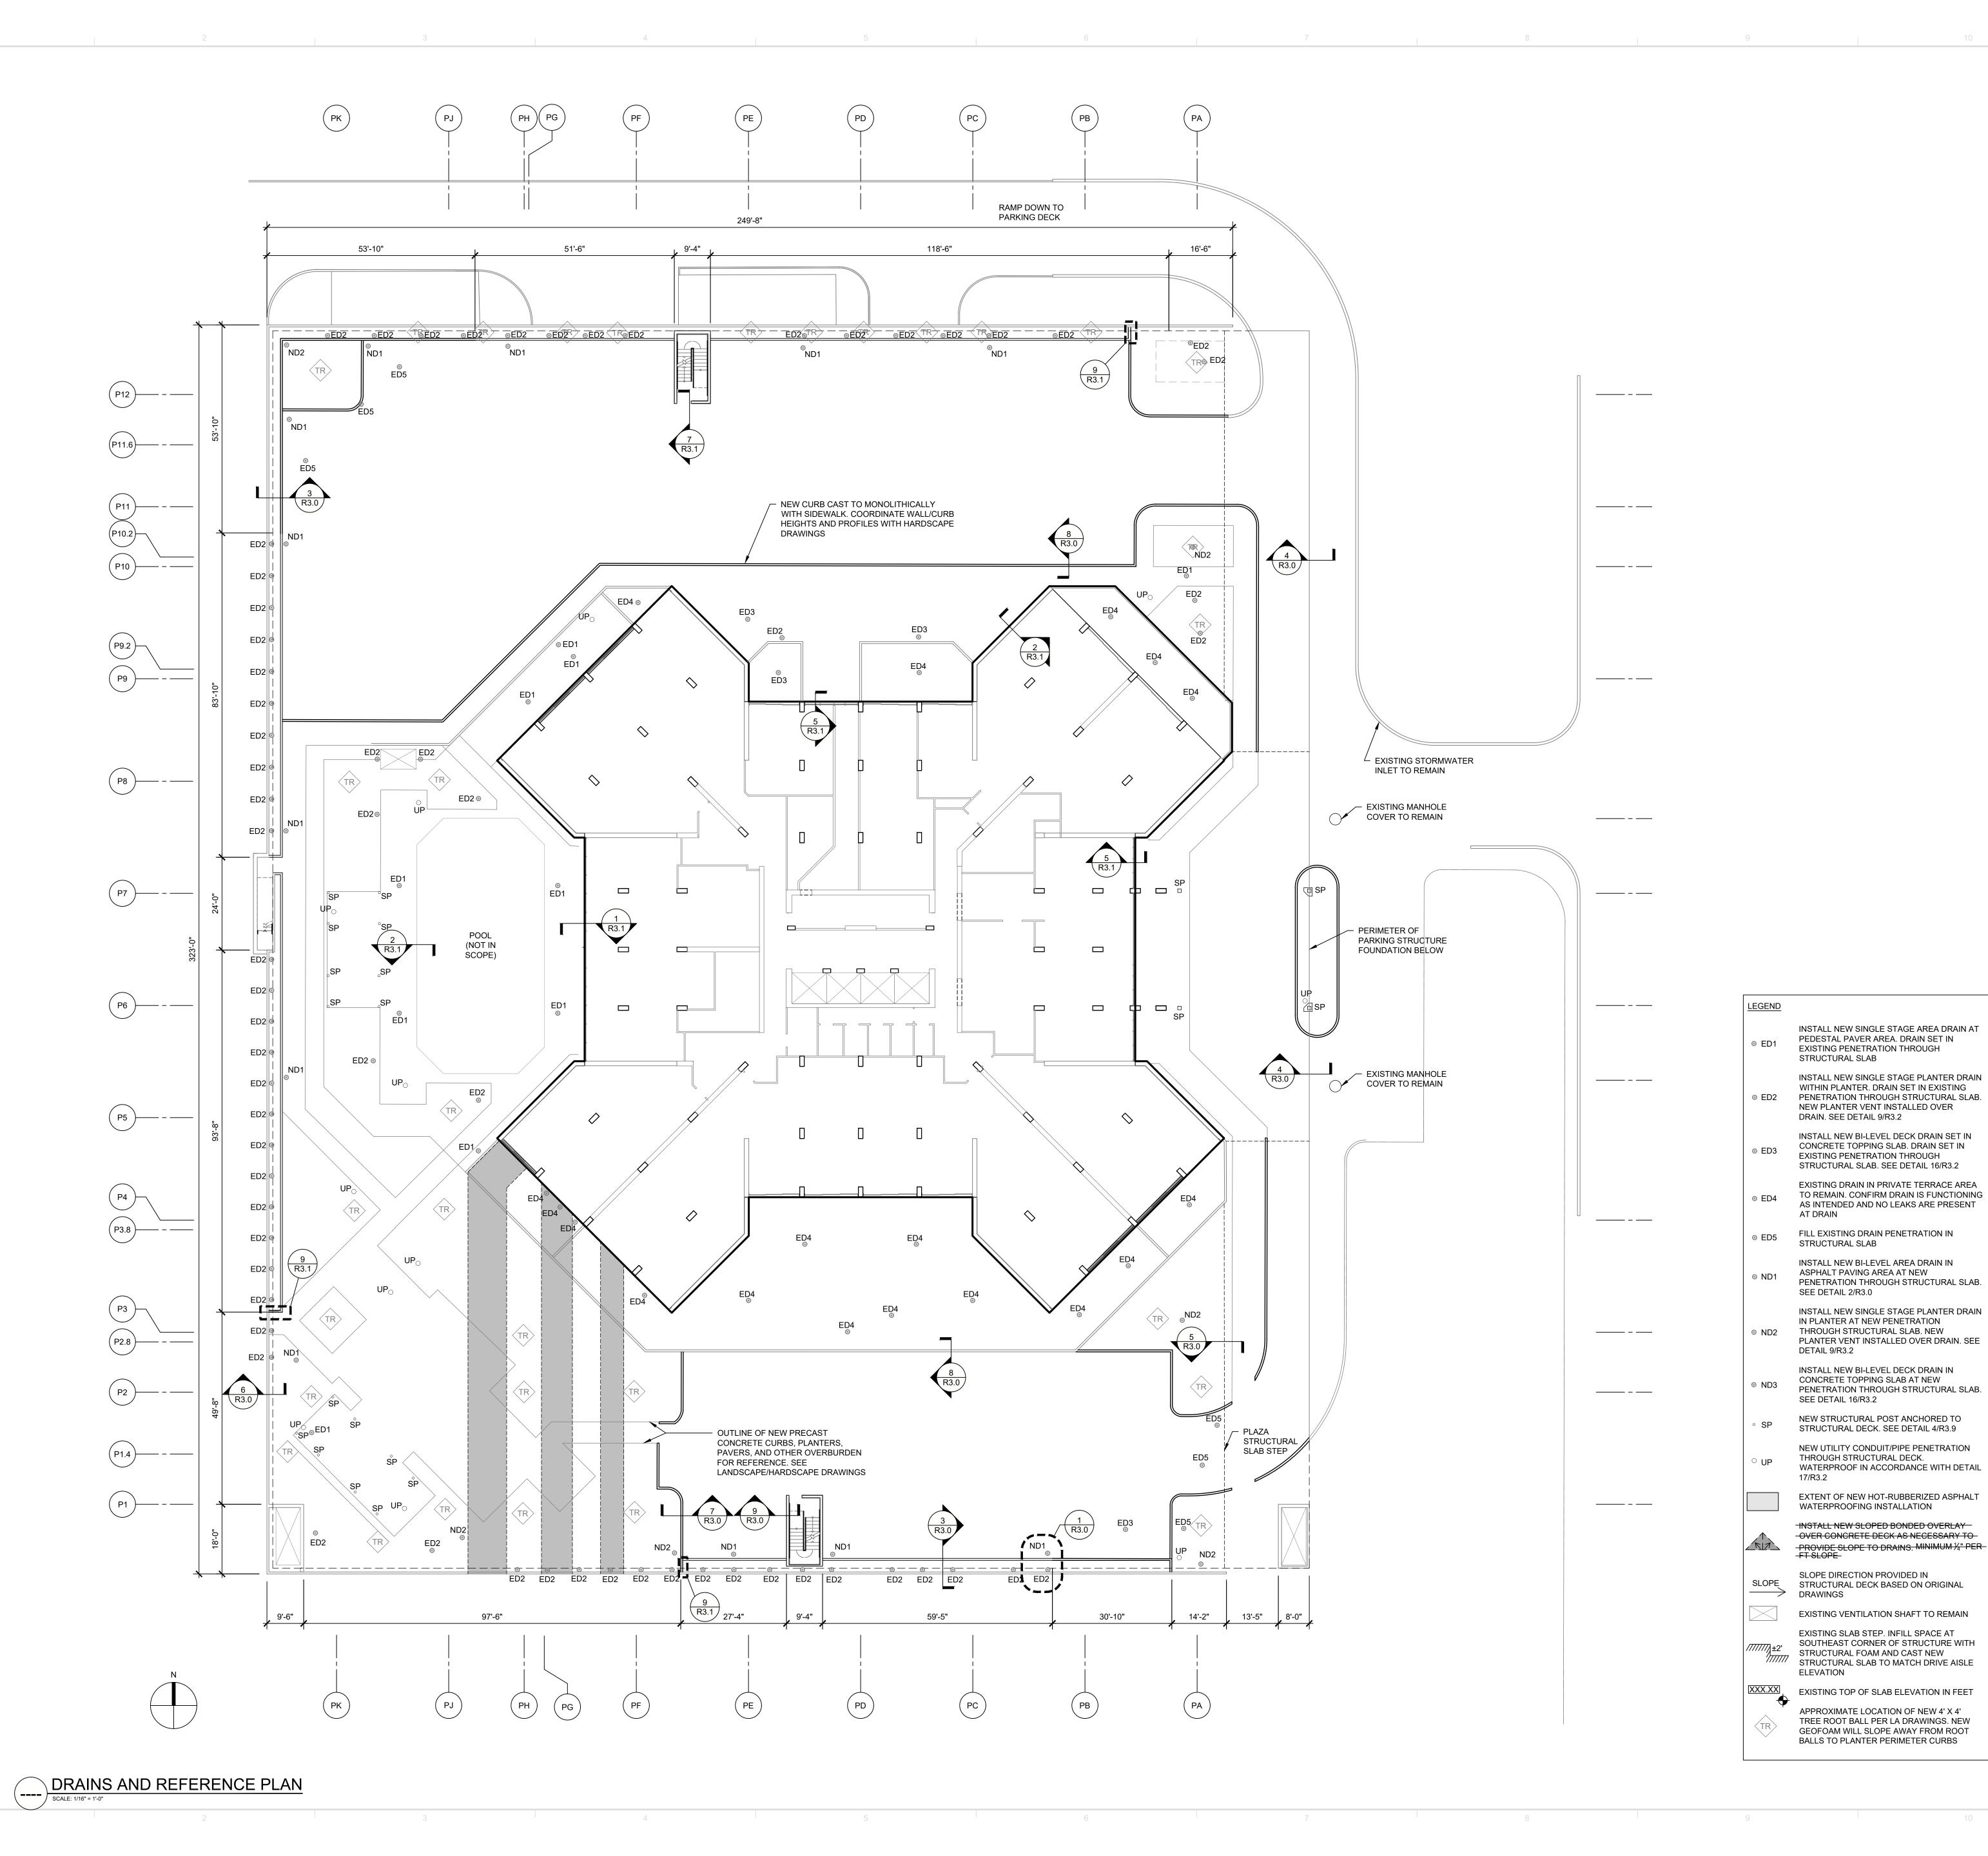
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Scale As Noted

Waterproofing Plan

R1_1



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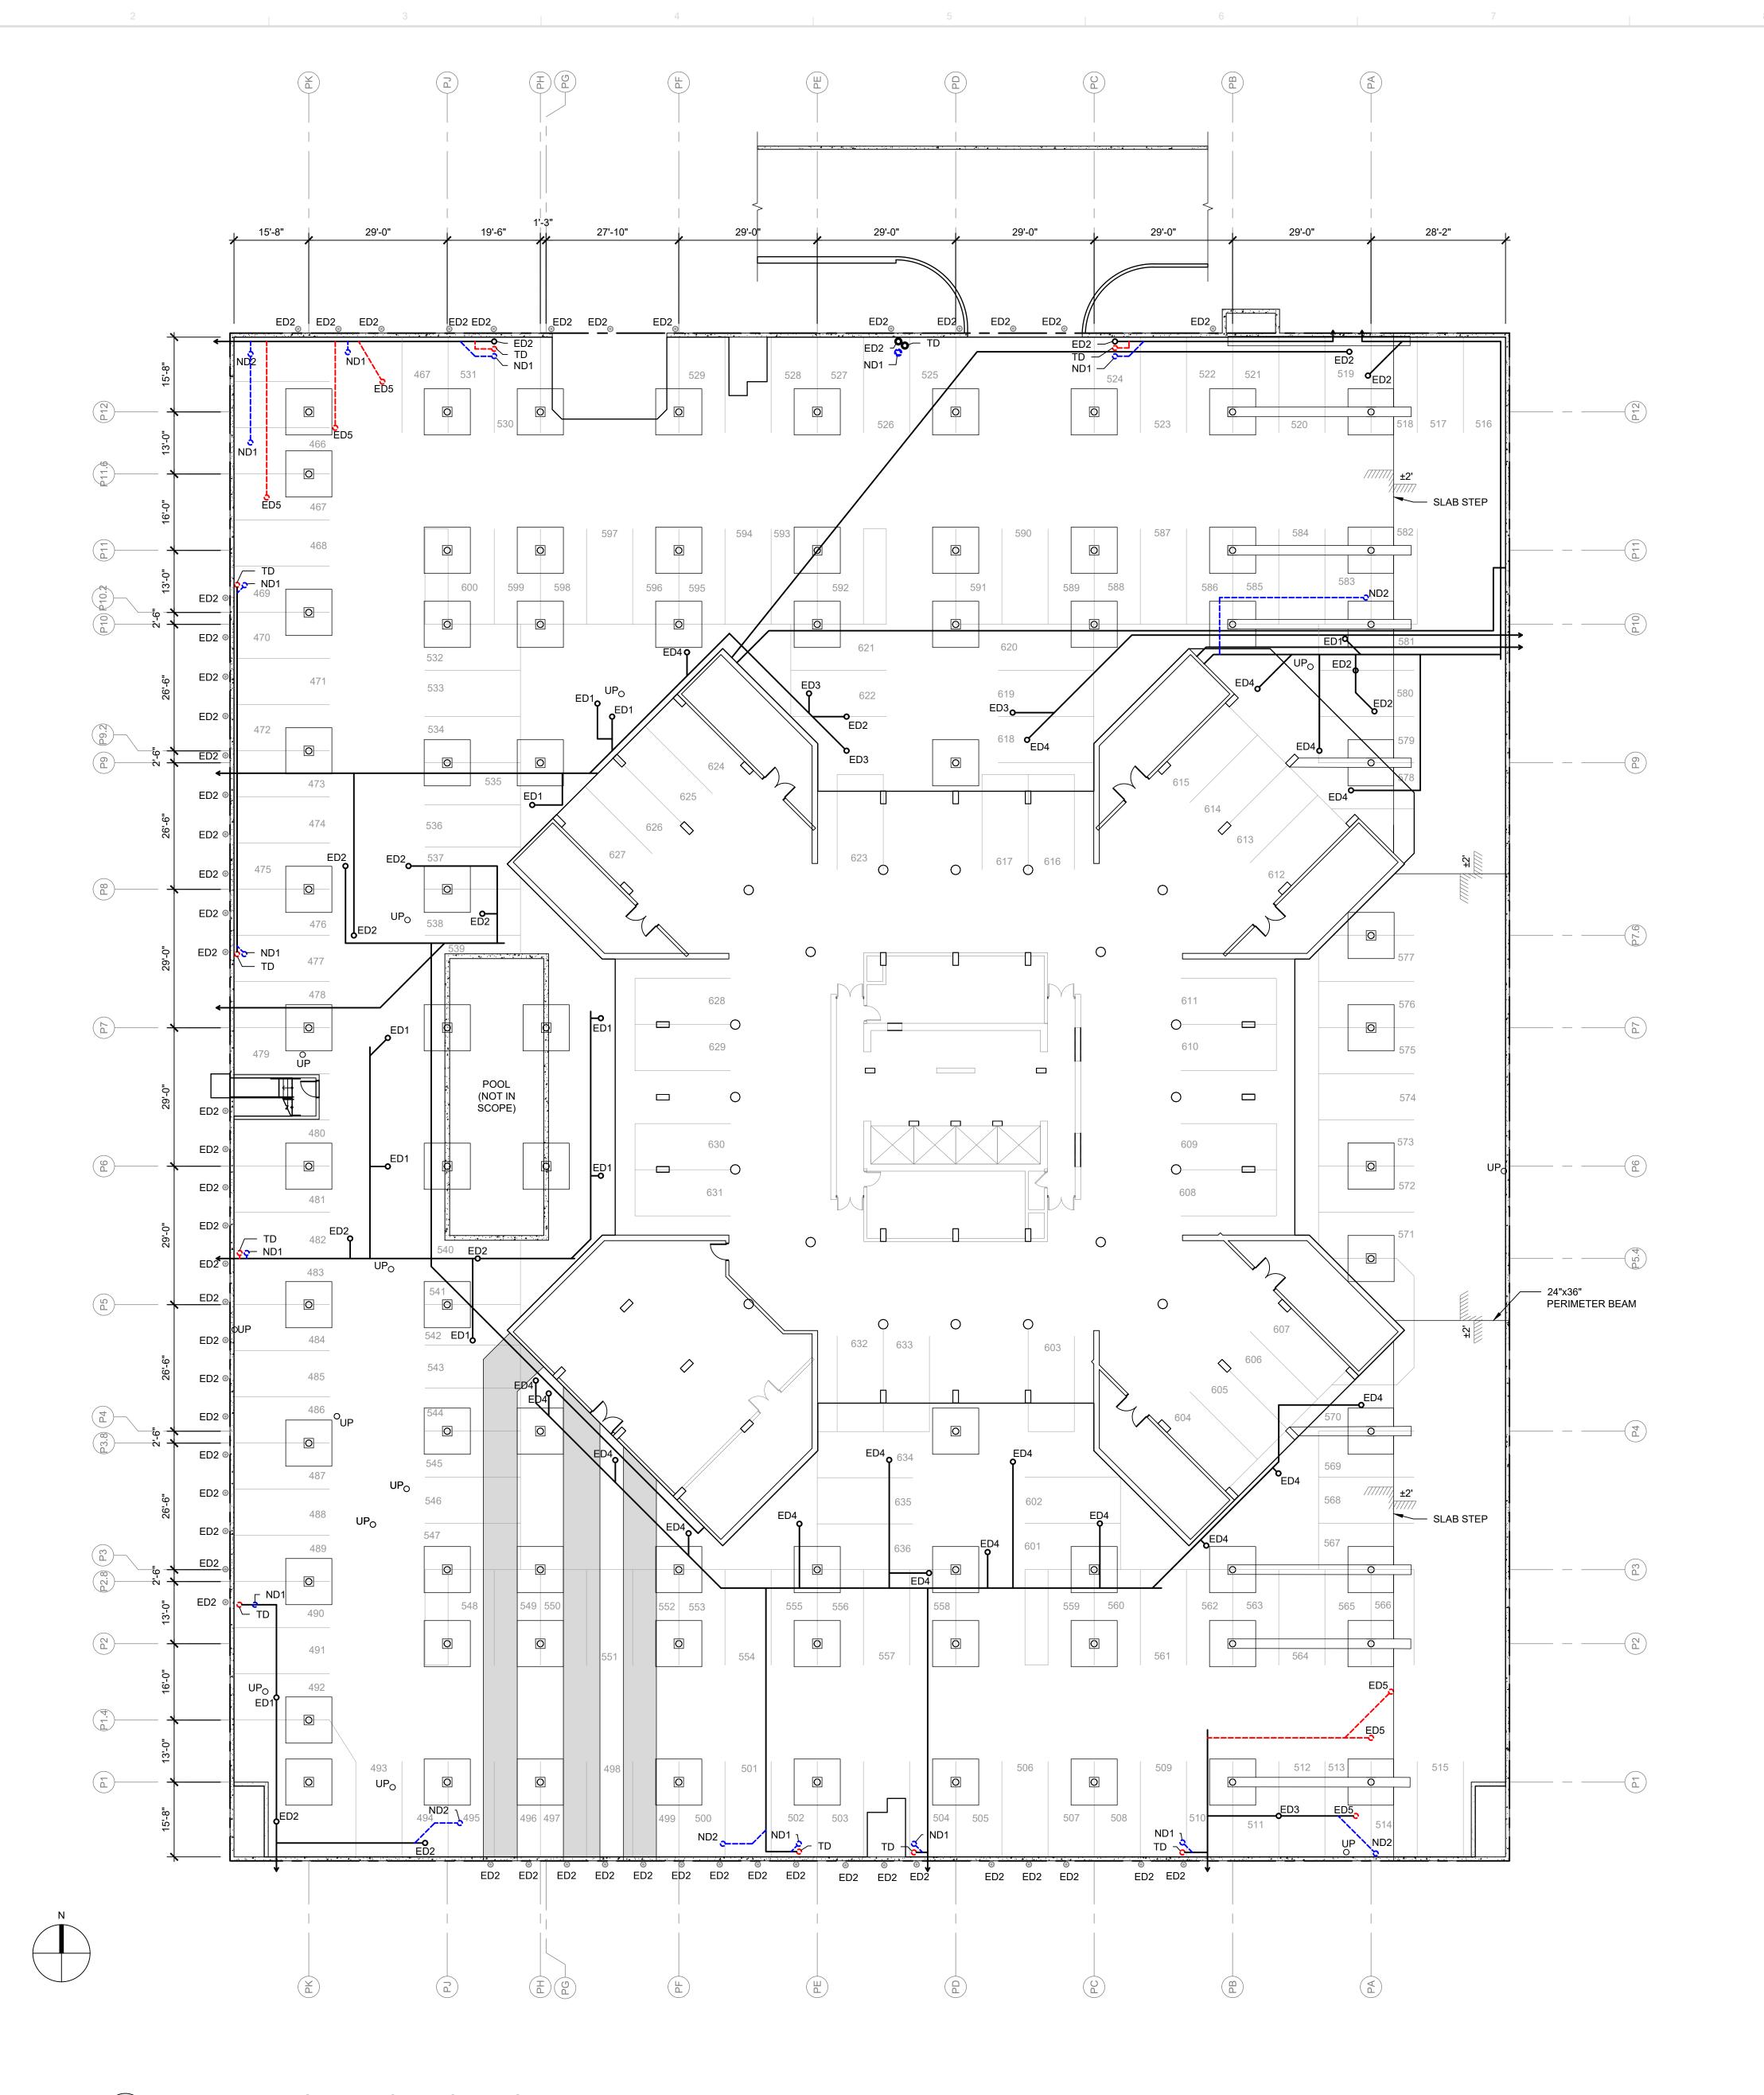
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Drain and Overburden

Sheet No.

R1.2



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INSTALL NEW SINGLE STAGE AREA DRAIN AT PEDESTAL PAVER AREA. DRAIN SET IN EXISTING PENETRATION THROUGH

INSTALL NEW SINGLE STAGE PLANTER DRAIN WITHIN PLANTER. DRAIN SET IN EXISTING PENETRATION THROUGH STRUCTURAL SLAB. NEW PLANTER VENT INSTALLED OVER

INSTALL NEW BI-LEVEL DECK DRAIN SET IN CONCRETE TOPPING SLAB. DRAIN SET IN EXISTING PENETRATION THROUGH STRUCTURAL SLAB. SEE DETAIL 16/R3.2

EXISTING DRAIN IN PRIVATE TERRACE AREA

FILL EXISTING DRAIN PENETRATION IN STRUCTURAL SLAB

INSTALL NEW BI-LEVEL AREA DRAIN IN ASPHALT PAVING AREA AT NEW

IN PLANTER AT NEW PENETRATION

THROUGH STRUCTURAL SLAB. NEW

INSTALL NEW BI-LEVEL DECK DRAIN IN

EXISTING TRENCH DRAIN PIPE TO BE

INSTALL NEW PVC DRAIN PIPE AND PIPE

EXISTING DRAIN PIPE TO BE CAPPED OR REMOVED FOLLOWING REMOVAL OF

NEW UTILITY CONDUIT/PIPE PENETRATION THROUGH STRUCTURAL DECK. WATERPROOF IN ACCORDANCE WITH DETAIL

LOCATION OF EXISTING GEORGIA POWER

EXISTING SLAB STEP. INFILL SPACE AT

STRUCTURAL FOAM AND CAST NEW STRUCTURAL SLAB TO MATCH DRIVE AISLE

EXISTING DROP PANELS AT COLUMNS WITHIN GARAGE. DO NOT PENETRATE PANELS DURING PLAZA RENOVATION.

SOUTHEAST CORNER OF STRUCTURE WITH

TD REMOVED AND SLAB PENETRATION TO BE

HANGERS IN ACCORDANCE WITH

SEE DETAIL 2/R3.0

DETAIL 9/R3.2

SEE DETAIL 16/R3.2

EXISTING DRAIN PIPE TO REMAIN

APPLICABLE CODES

BANK CONDUIT BUNDLES

EXISTING DRAIN

ELEVATION

PENETRATION THROUGH STRUCTURAL SLAB.

INSTALL NEW SINGLE STAGE PLANTER DRAIN

PLANTER VENT INSTALLED OVER DRAIN. SEE

CONCRETE TOPPING SLAB AT NEW PENETRATION THROUGH STRUCTURAL SLAB.

TO REMAIN. CONFIRM DRAIN IS FUNCTIONING AS INTENDED AND NO LEAKS ARE PRESENT

STRUCTURAL SLAB

DRAIN. SEE DETAIL 9/R3.2

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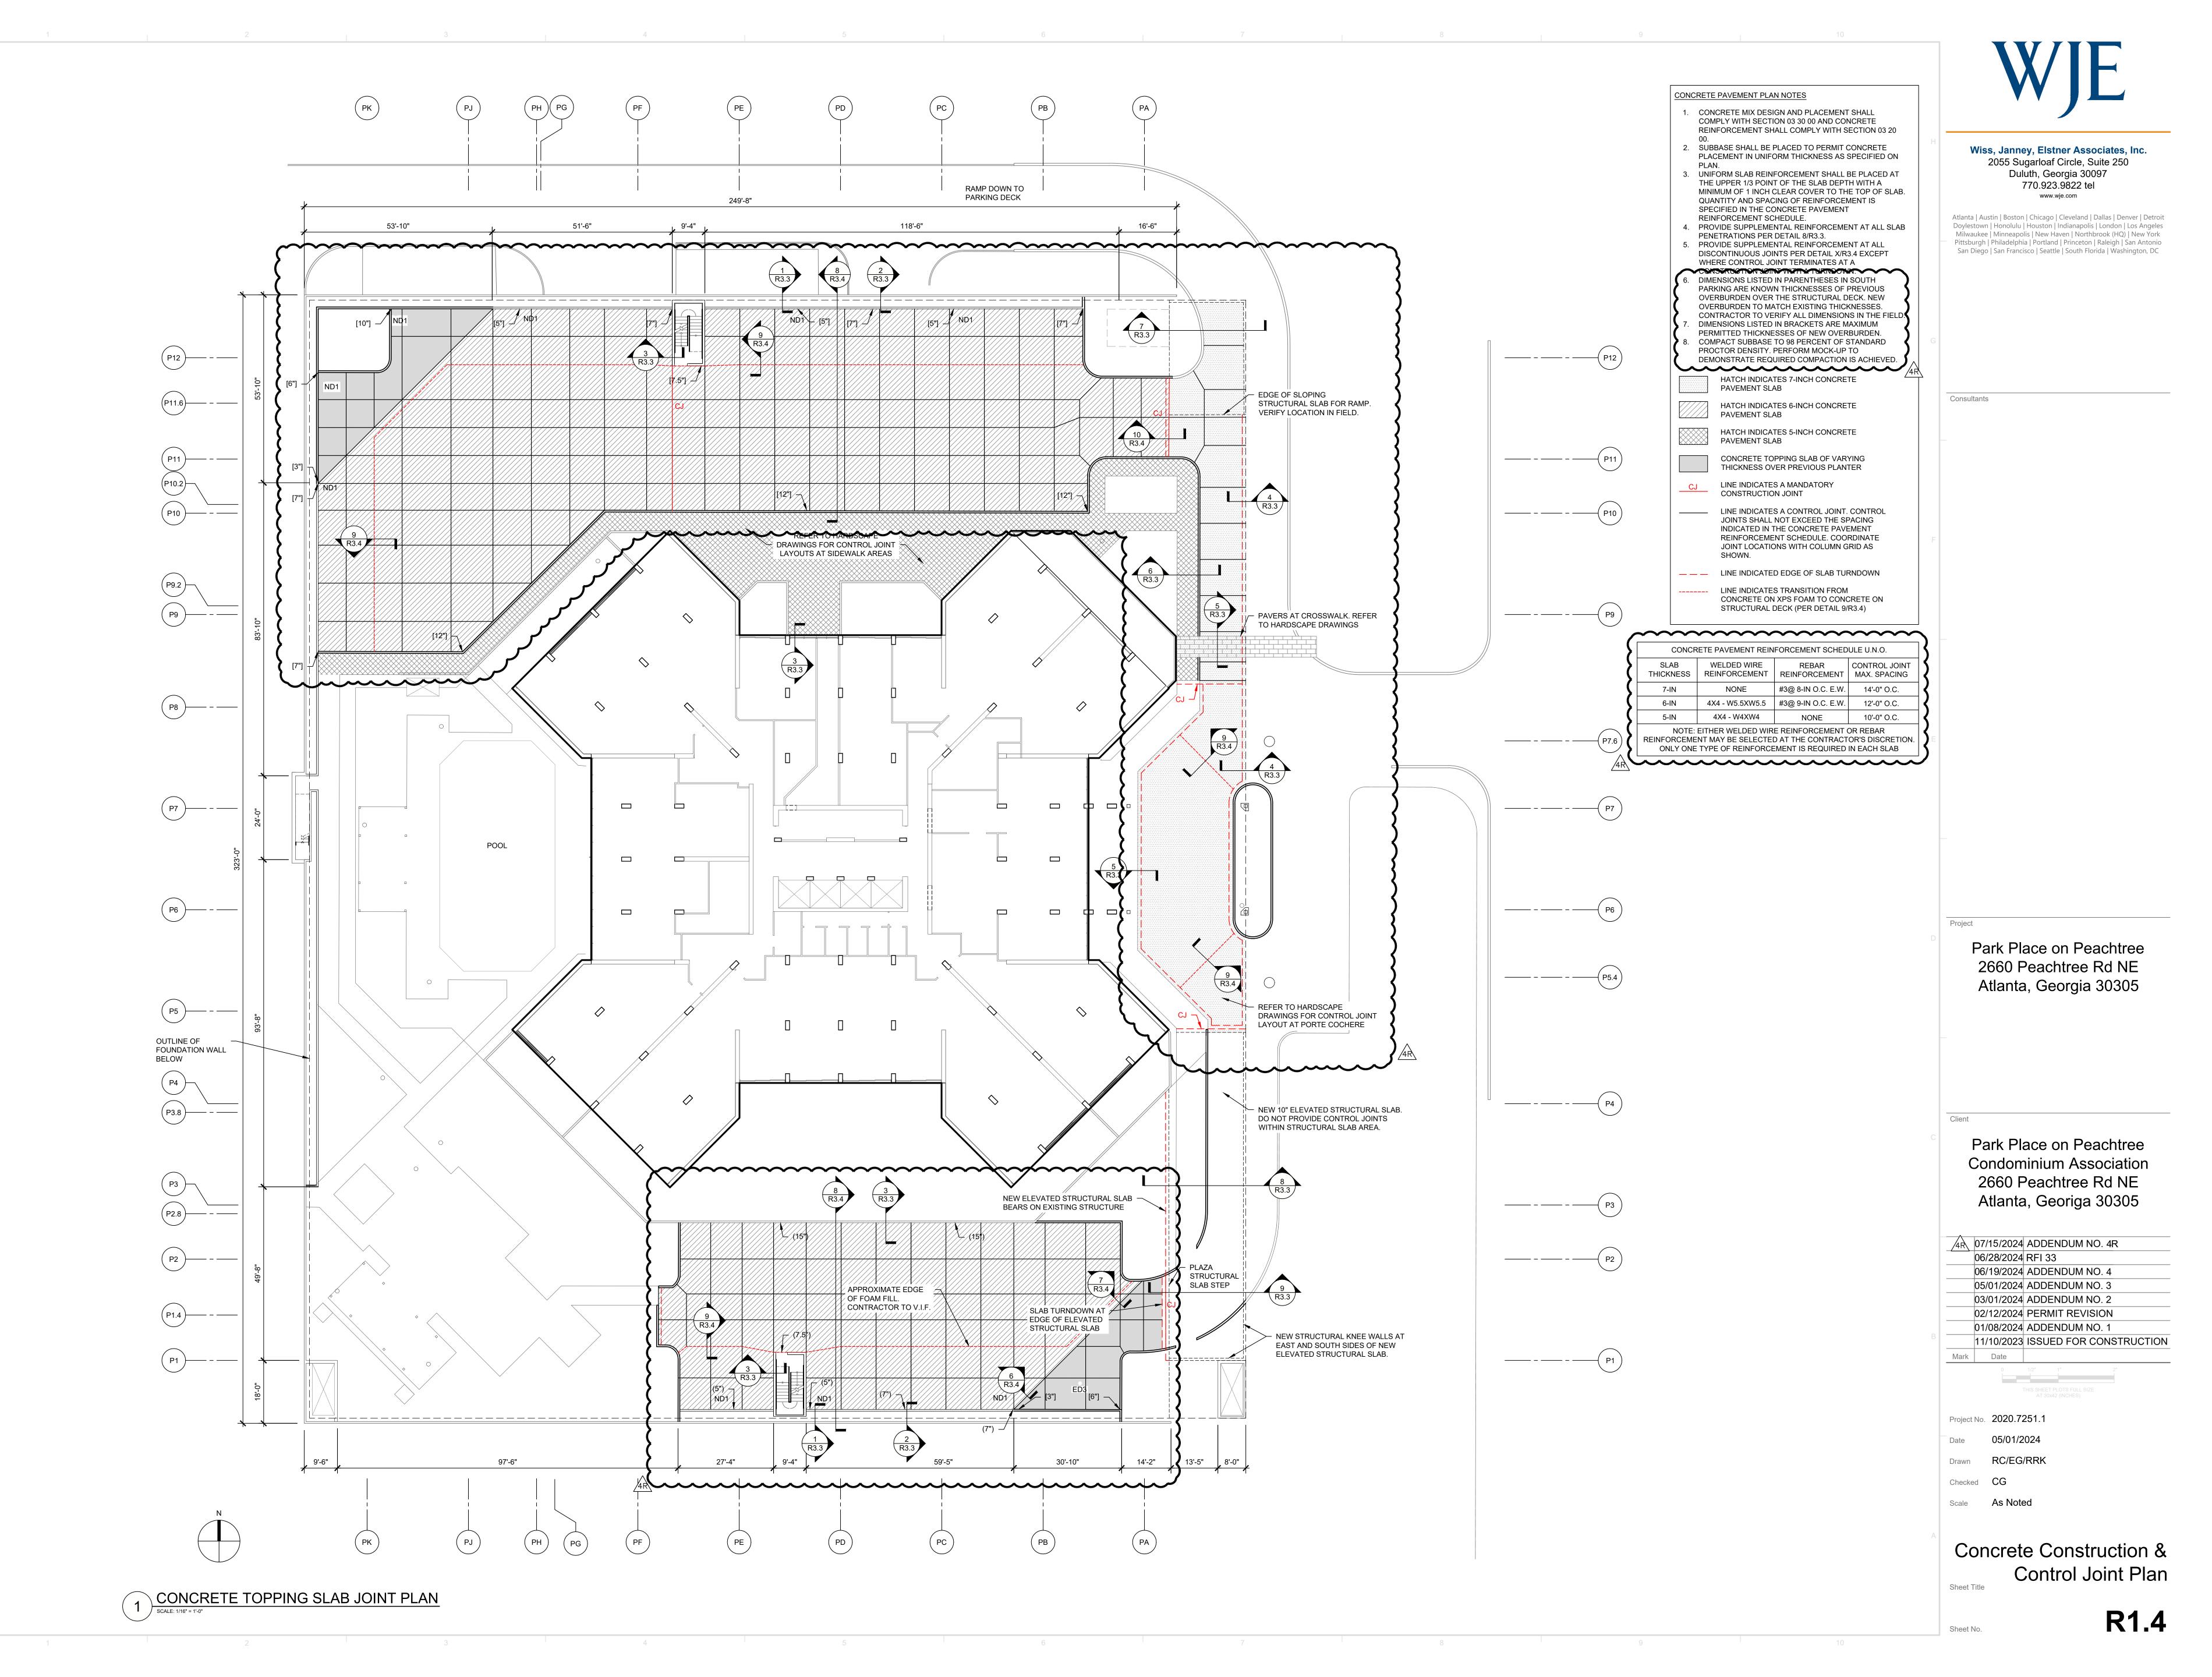
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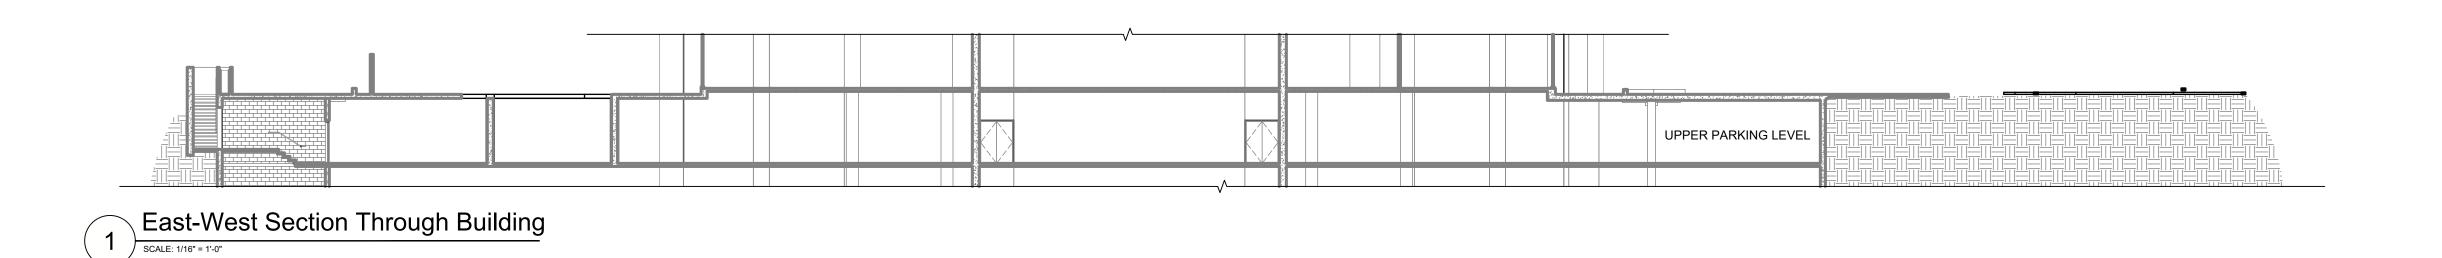
Upper Parking Level -


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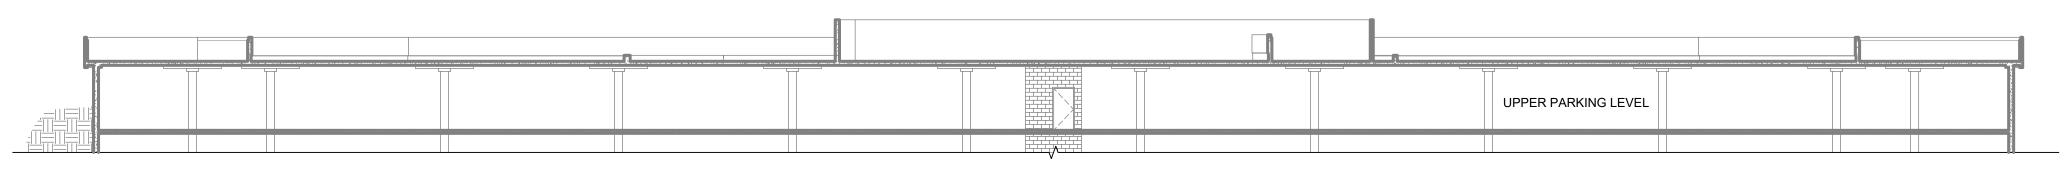
R1.3

VIPPER PARKING REFLECTED CEILING PLAN








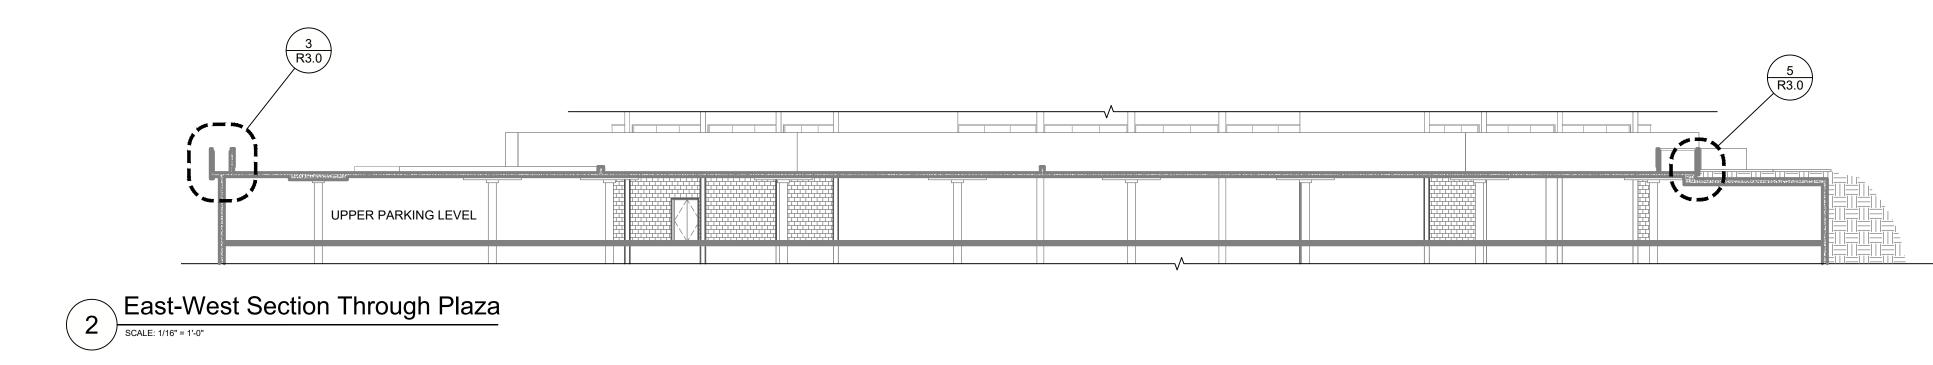

North-South Section Through Plaza

SCALE: 1/16" = 1'-0"

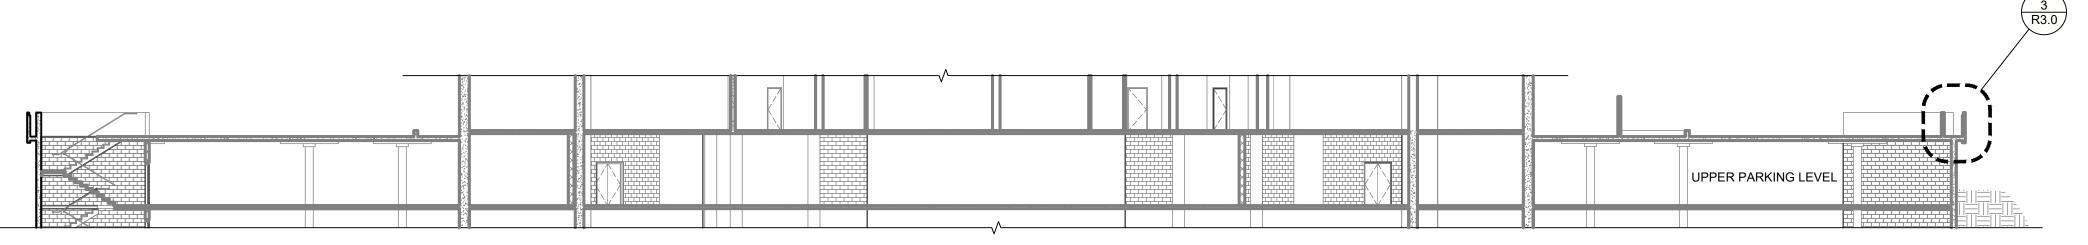

North-South Section Through Building

SCALE: 1/16" = 1'-0"



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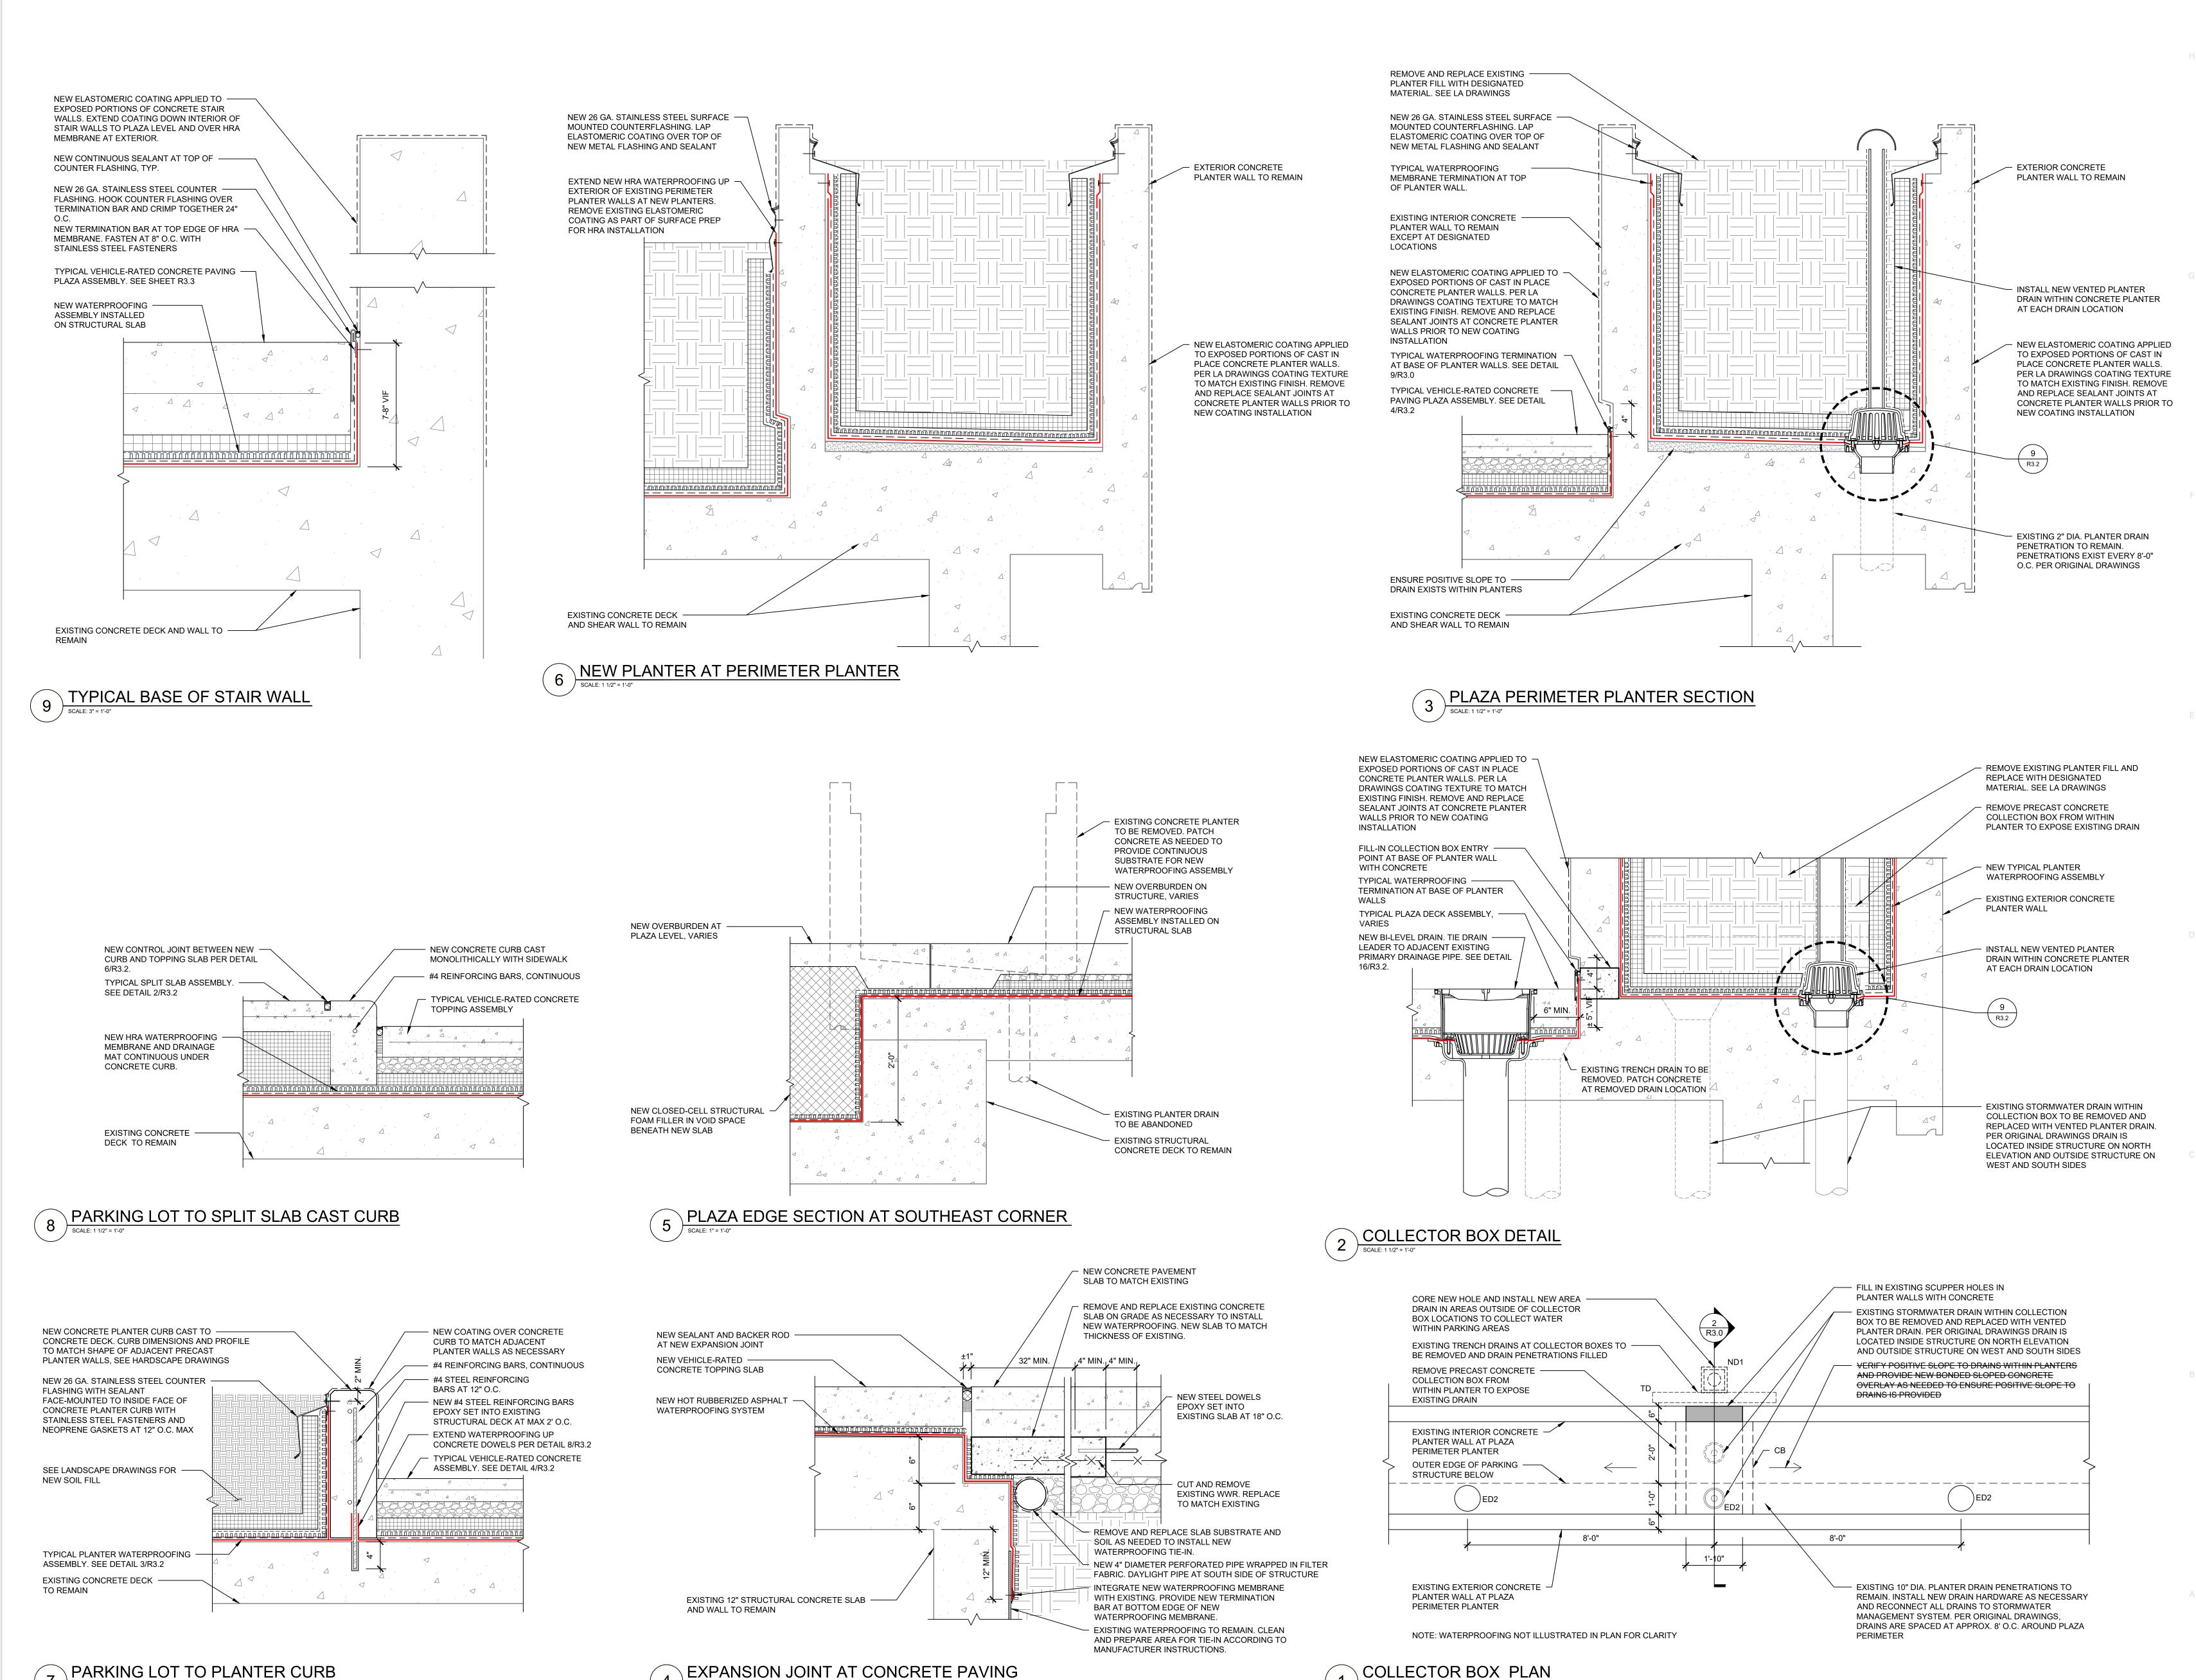
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Plaza Sections



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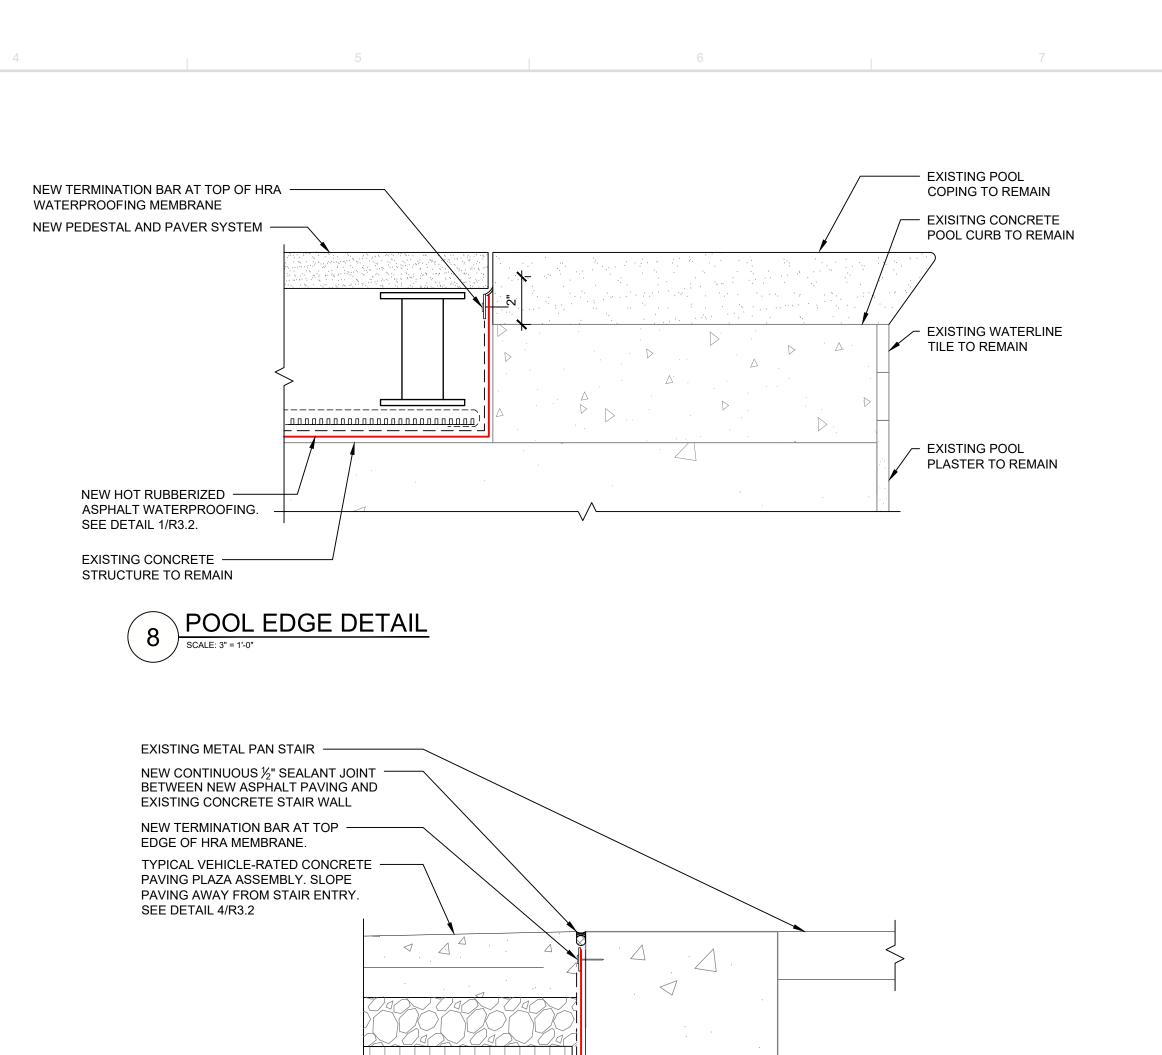
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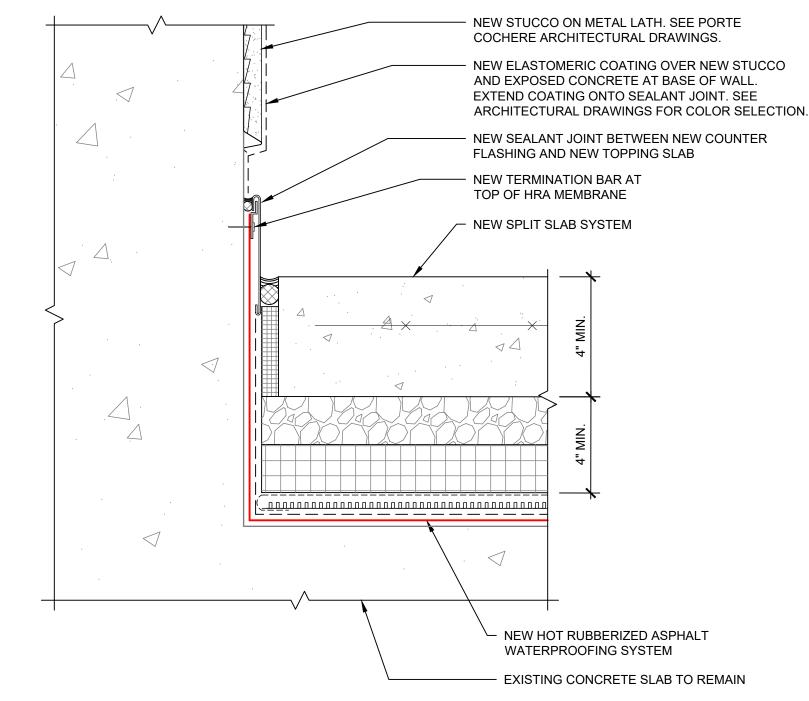
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Repair Details

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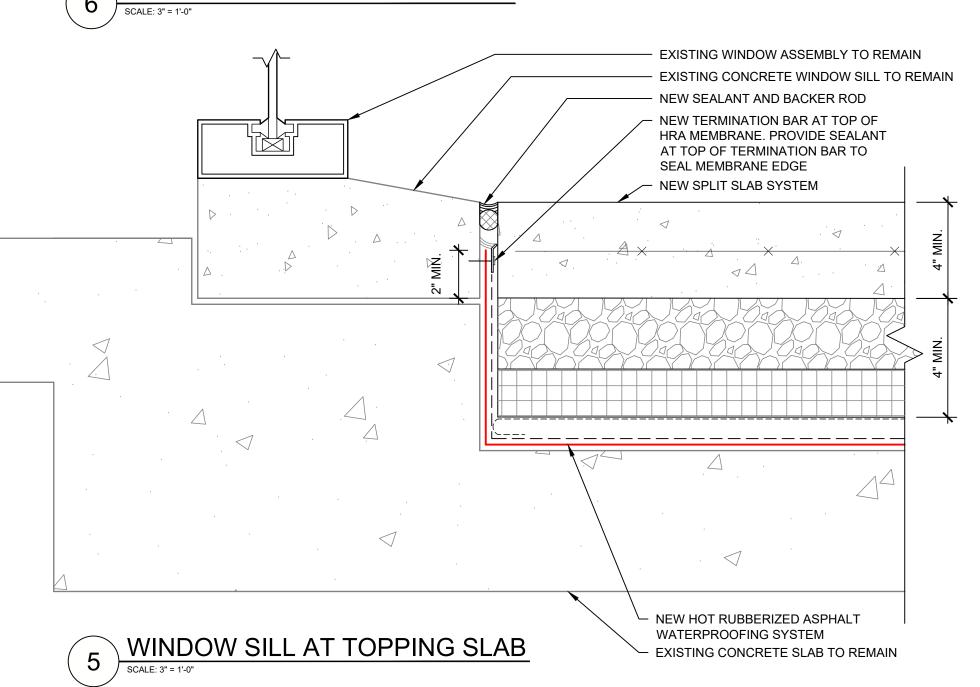



7 TYPICAL STAIR ENTRY DETAIL SCALE: 3" = 1'-0"




6 STUCCO BASE OF WALL DETAIL

SCALE: 3" = 1'-0"




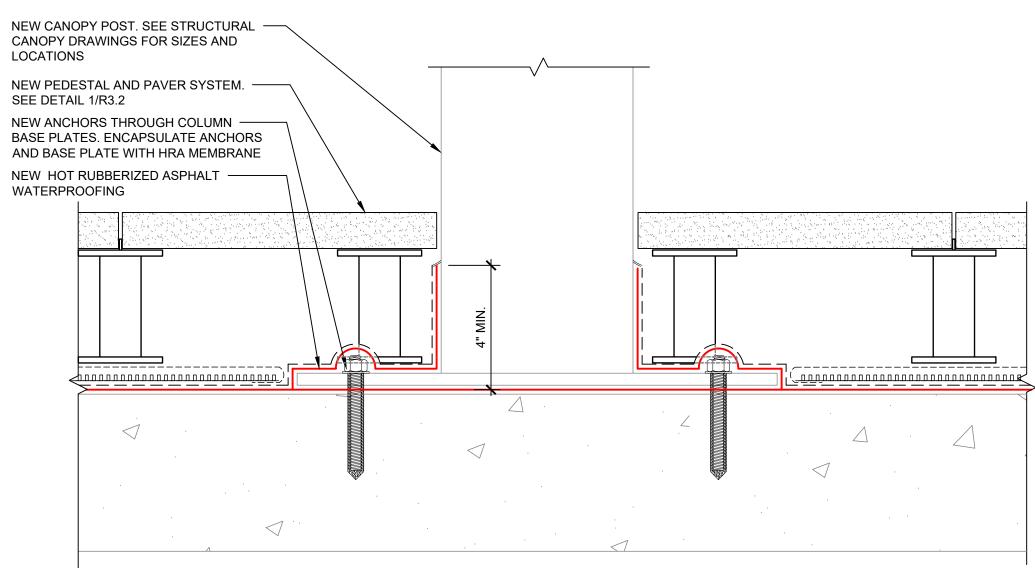


CANOPY COLUMN DETAIL

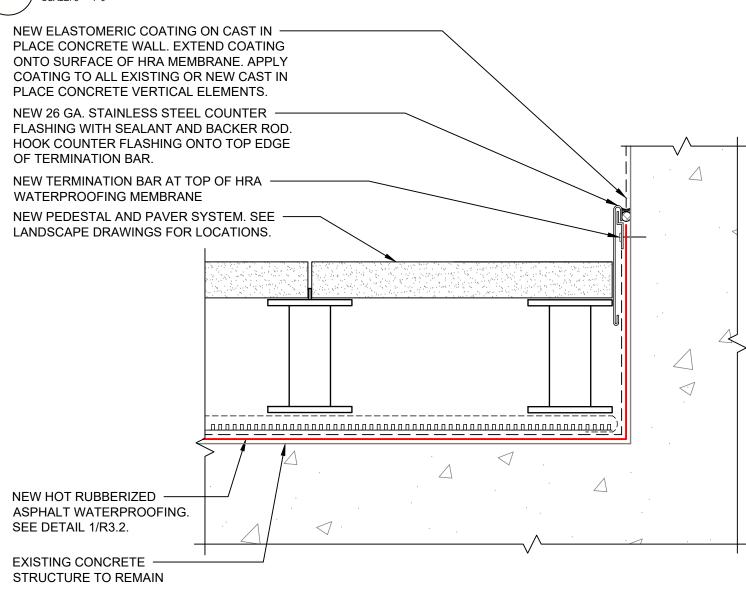

TYPICAL HRA BASE OF WALL AT PAVERS

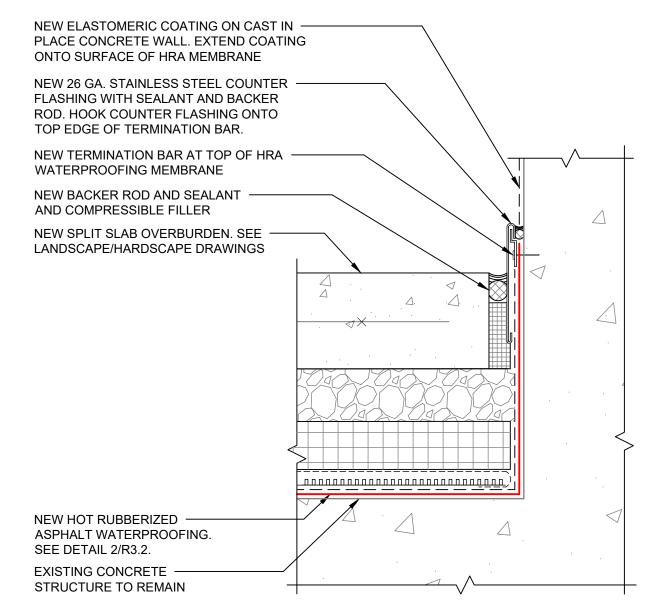

TYPICAL HRA BASE OF WALL AT TOPPING SLAB

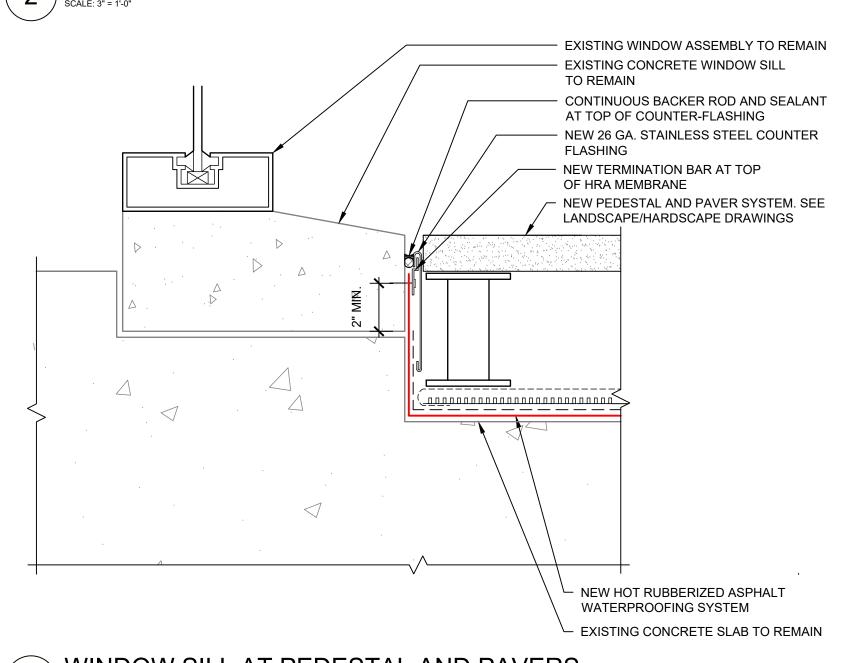

WINDOW SILL AT PEDESTAL AND PAVERS

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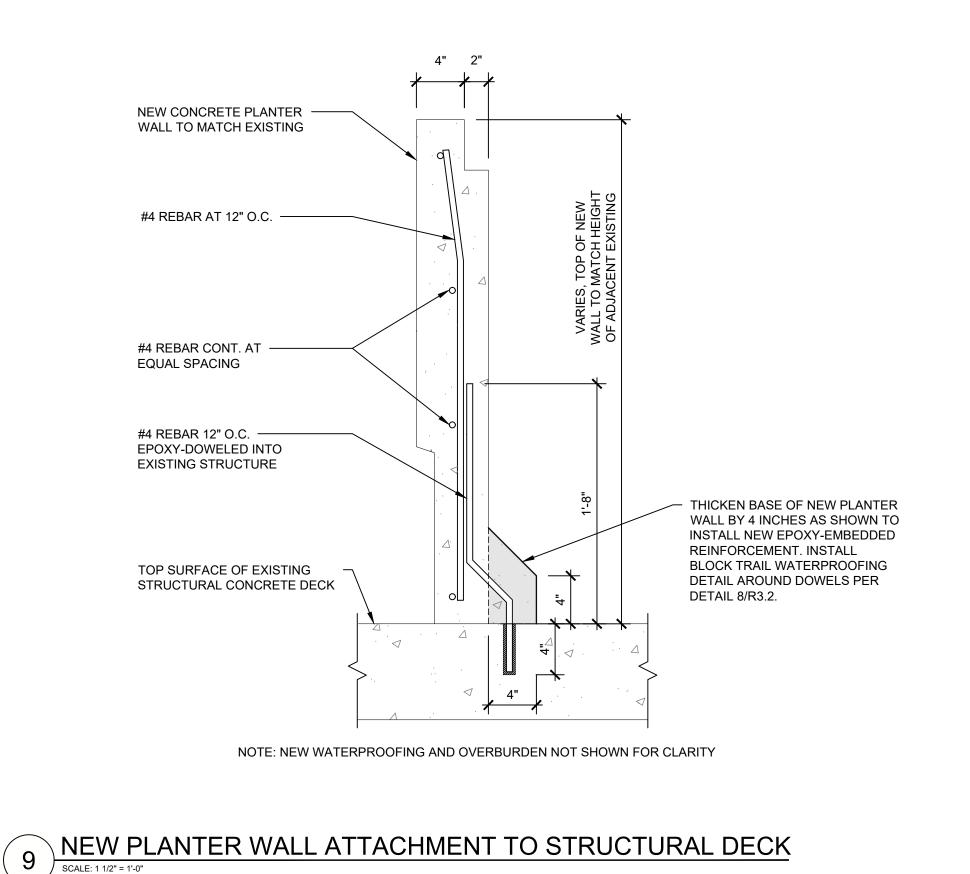
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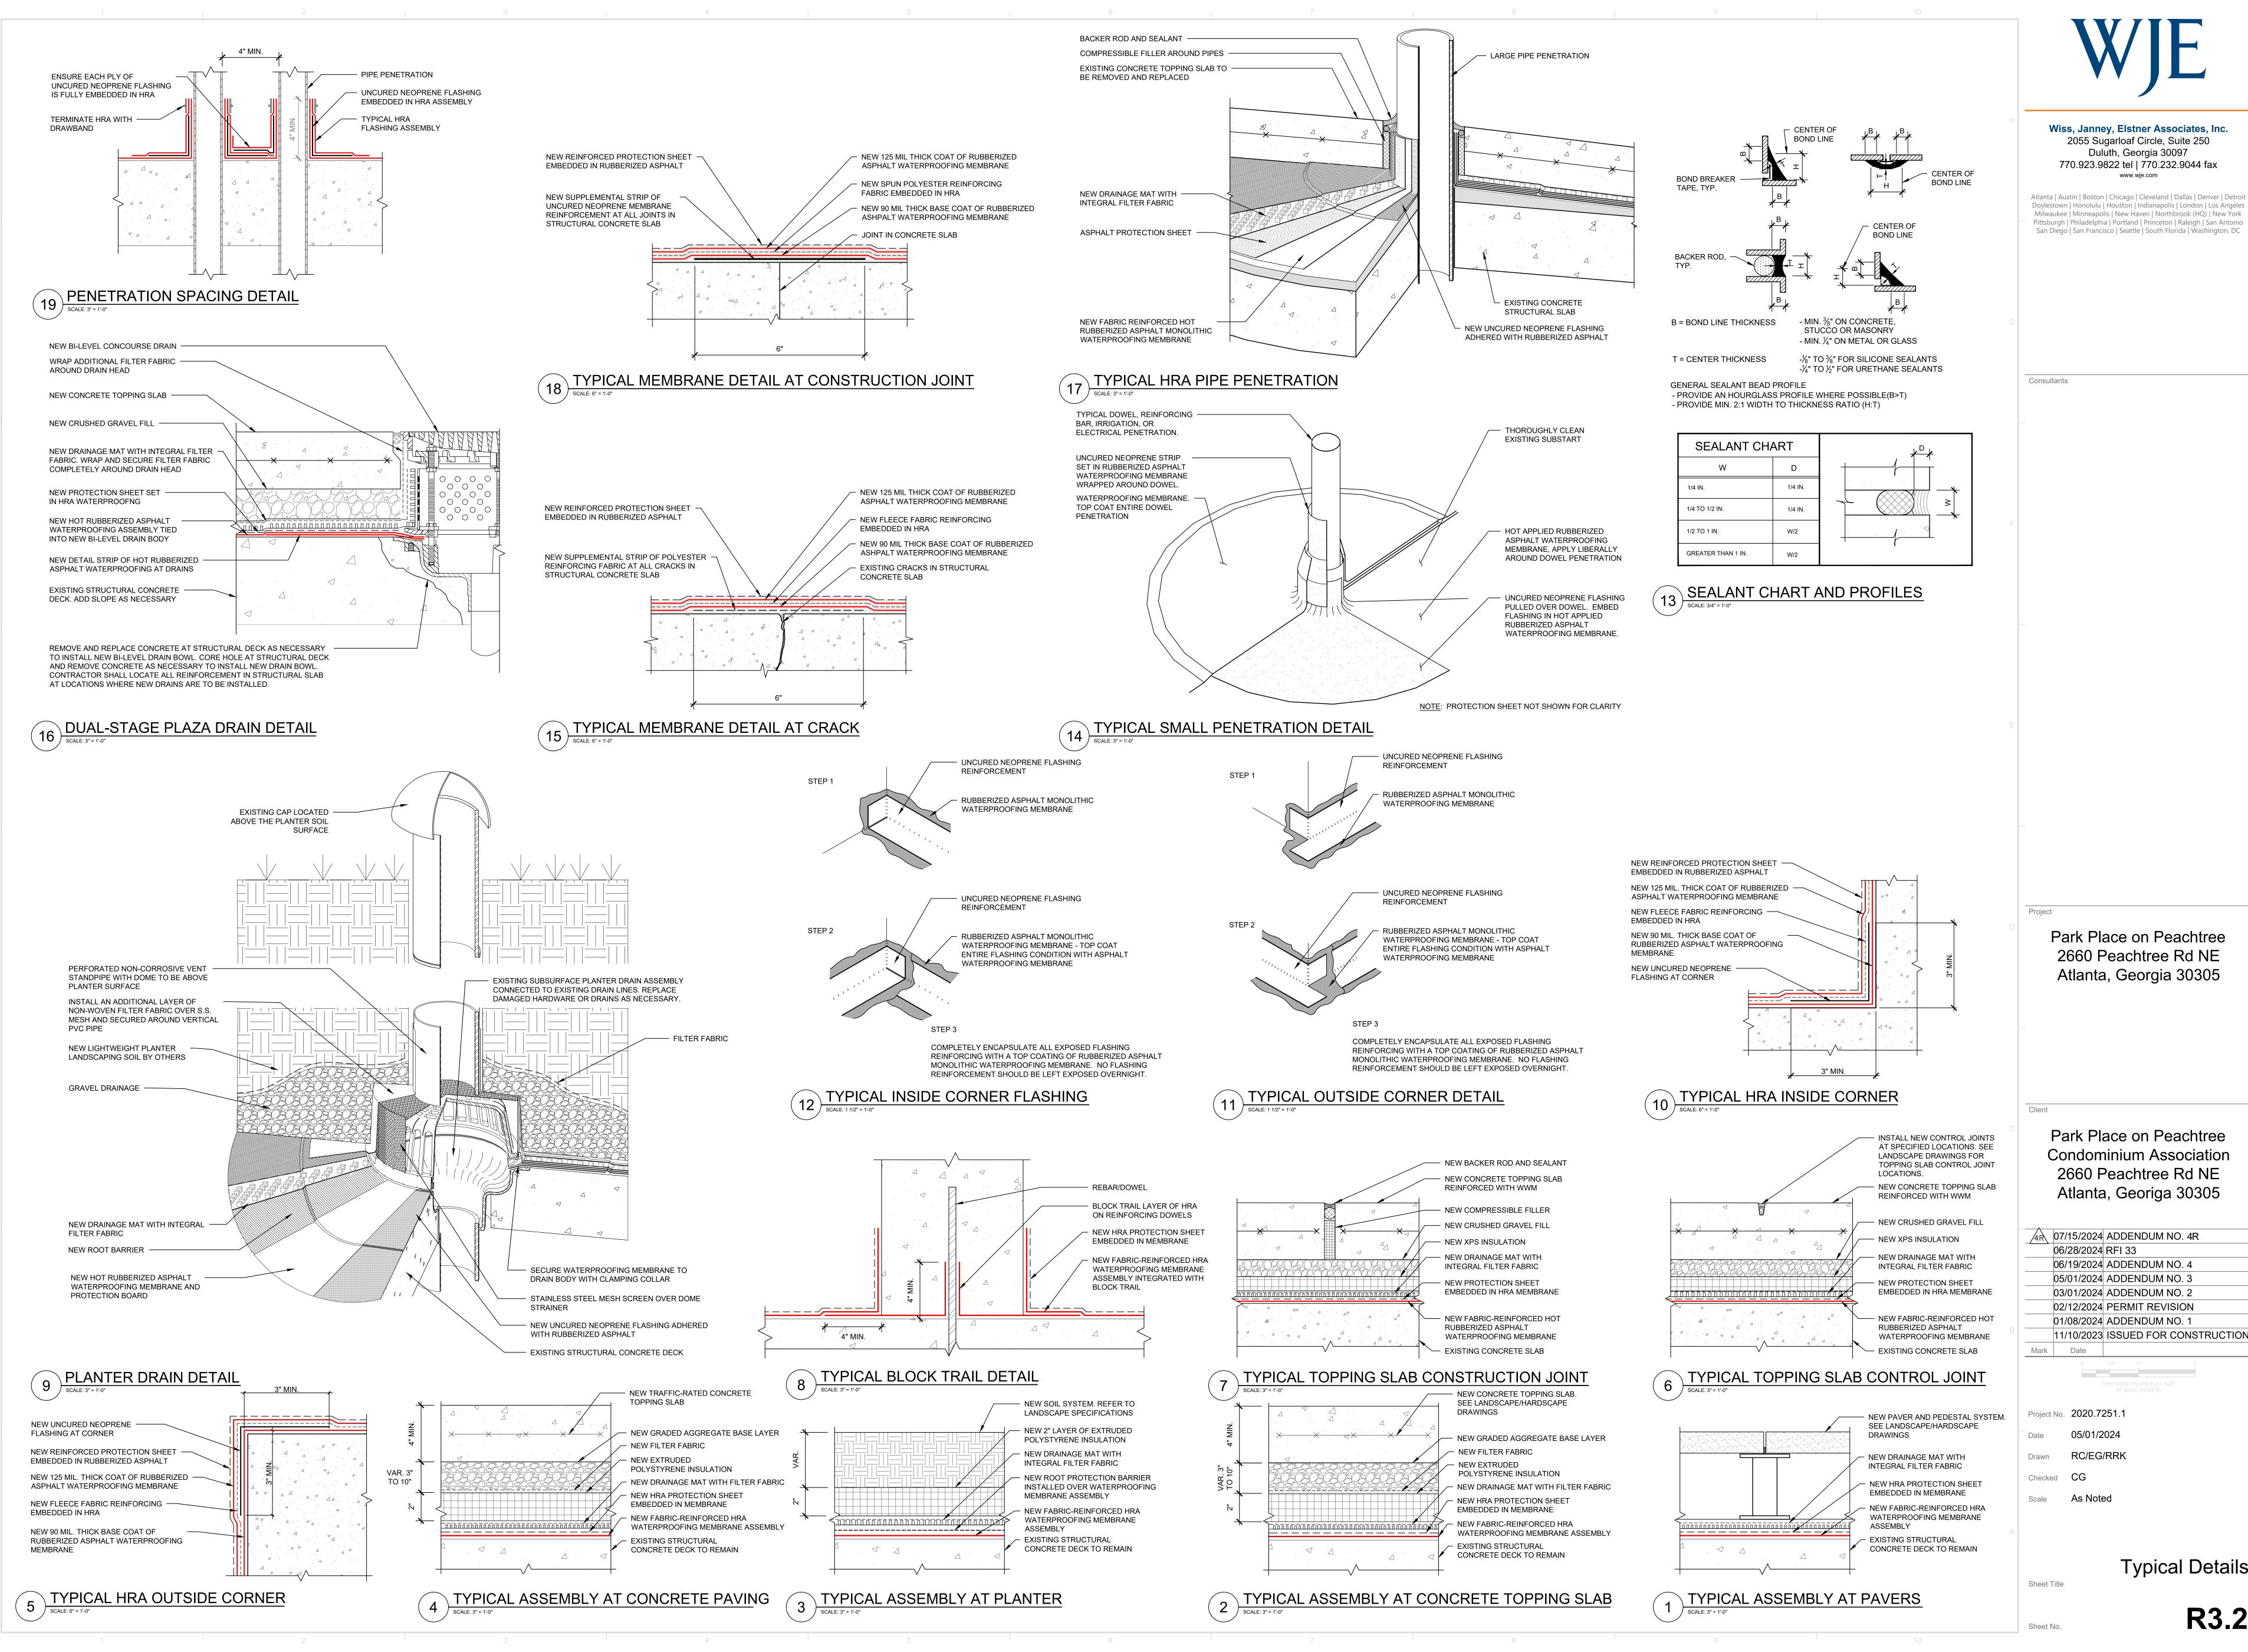
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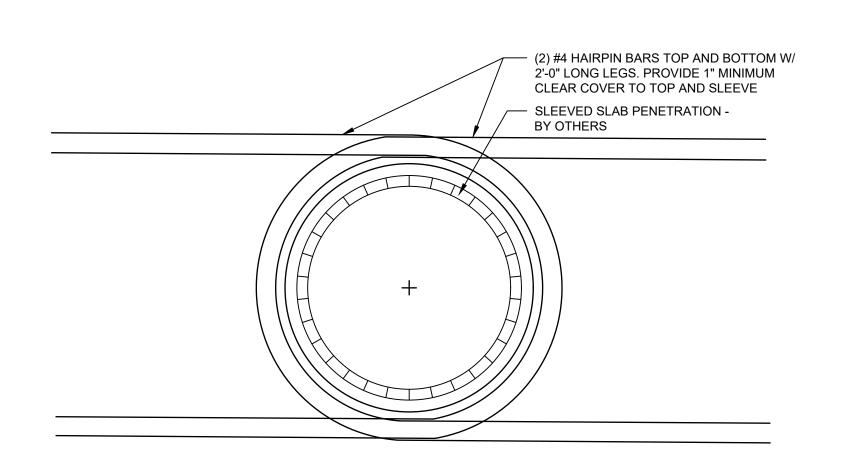
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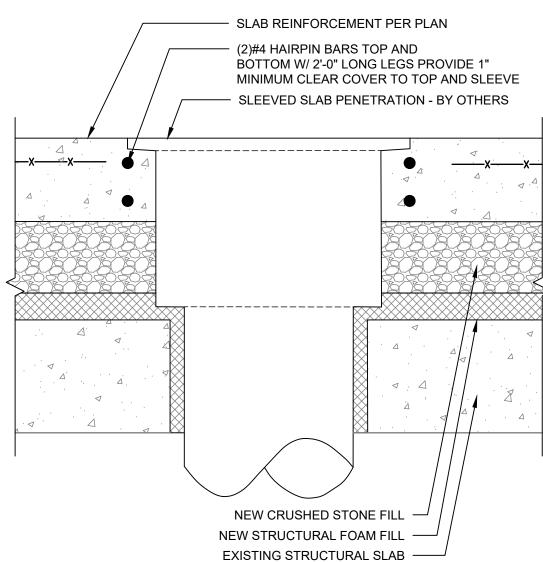
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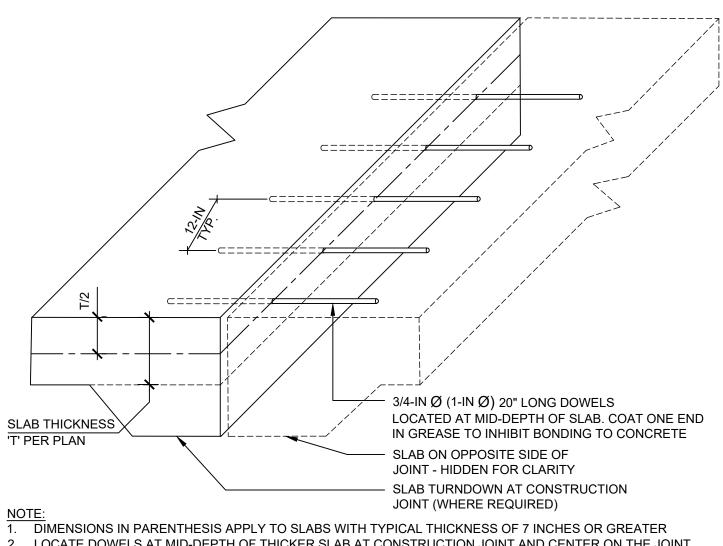
SLAB PENETRATION REINFORCEMENT (PLAN)



1. NO NEW SLAB PENETRATIONS SHALL BE PLACED WITHIN THE SLAB DROP PANEL REGION 2. CONTRACTOR SHALL NON-DESTRUCTIVELY LOCATE ALL EXISTING SLAB REINFORCEMENT


AND COORDINATE NEW SLAB PENETRATIONS TO AVOID EXISTING REINFORCEMENT.


SLAB PENETRATION REINFORCEMENT (SECTION)



2. LOCATE DOWELS AT MID-DEPTH OF THICKER SLAB AT CONSTRUCTION JOINT AND CENTER ON THE JOINT


CONSTRUCTION JOINT DOWEL DETAIL

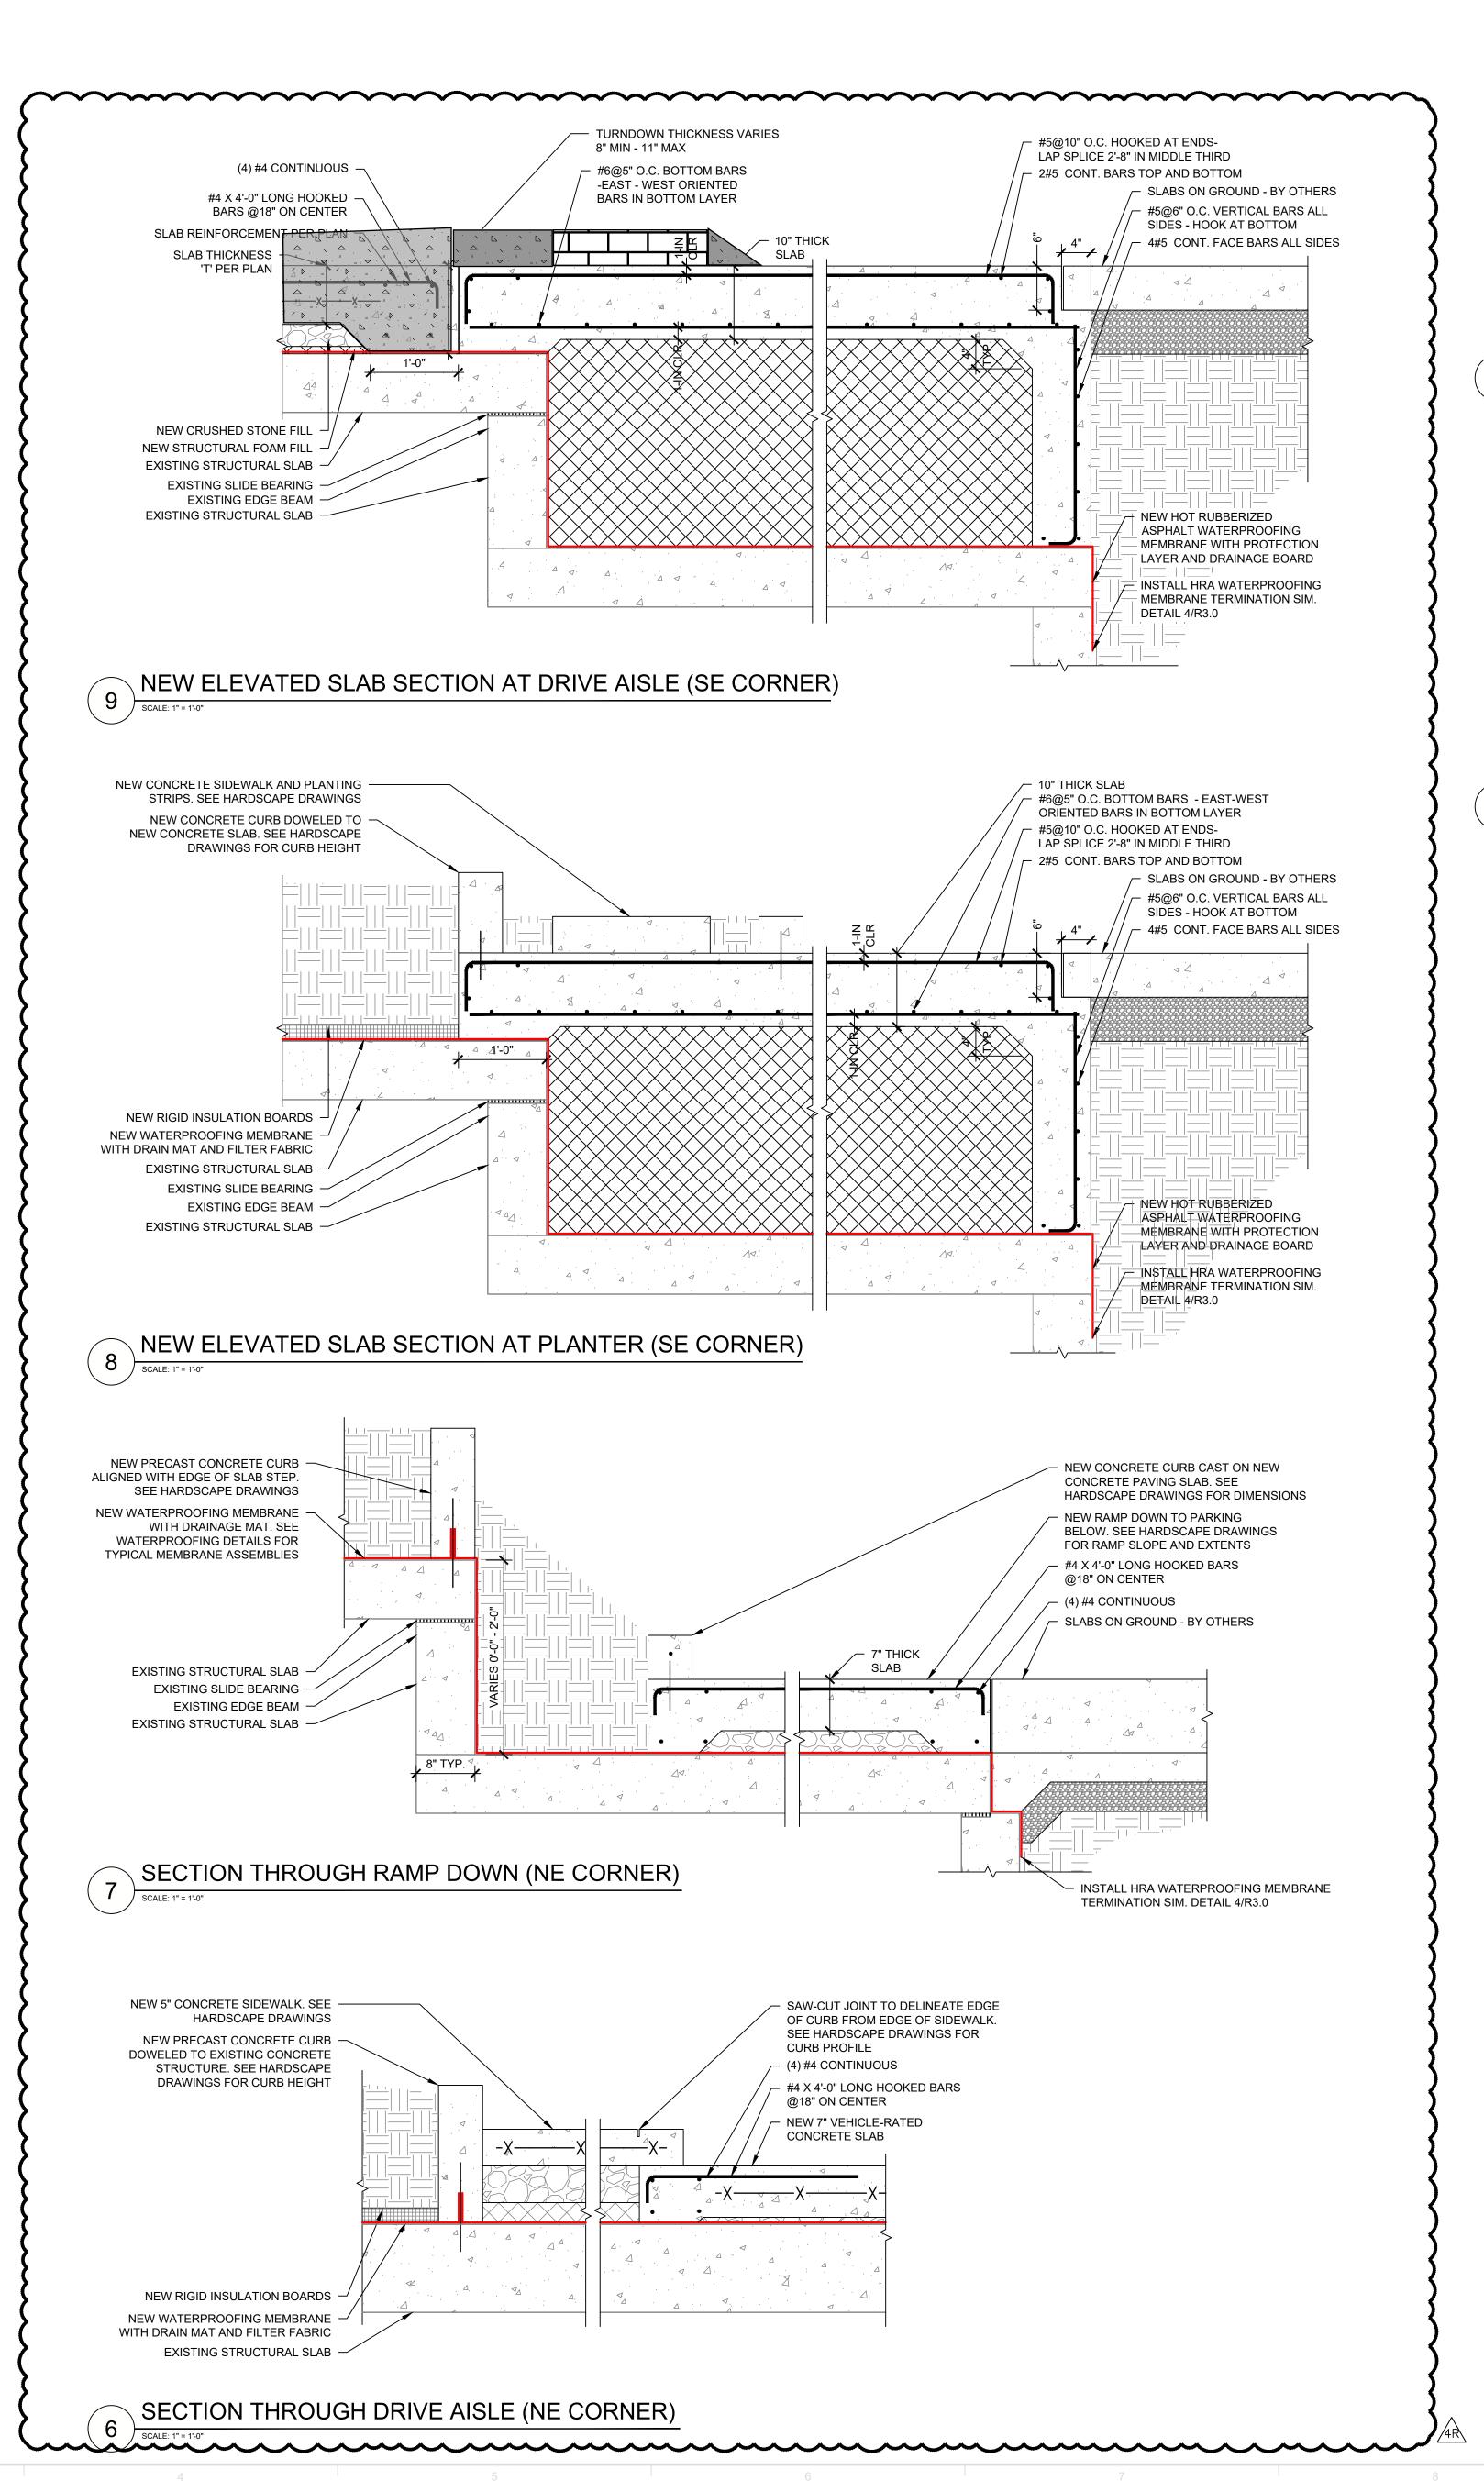

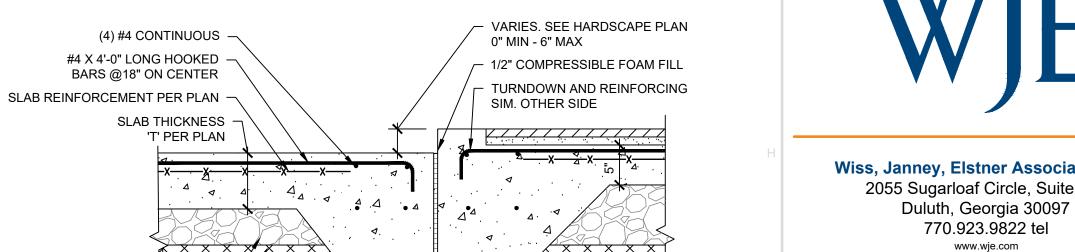


NEW CRUSHED STONE FILL NEW STRUCTURAL FOAM FILL EXISTING STRUCTURAL SLAB -


5 SLAB CONSTRUCTION JOINT AT SIDEWALK CURB

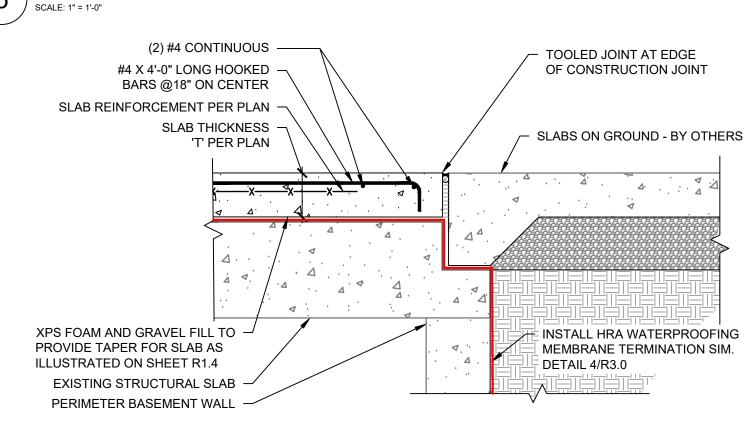


> PAVEMENT SLAB AT EDGE OF STRUCTURE

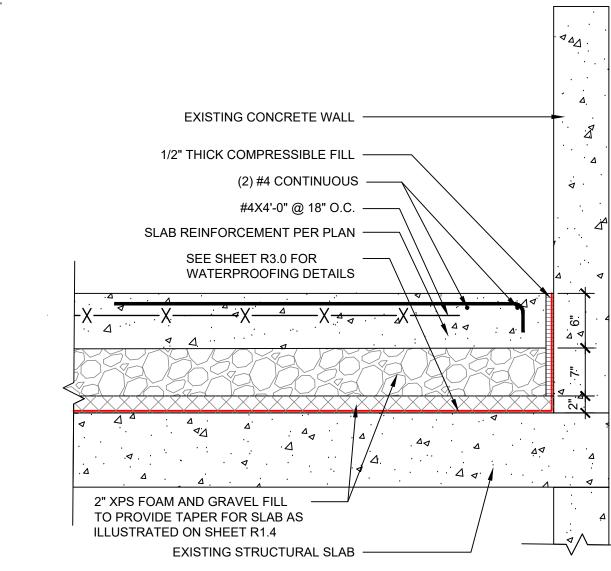

3 SLAB TERMINATION AT BUILDING EDGE

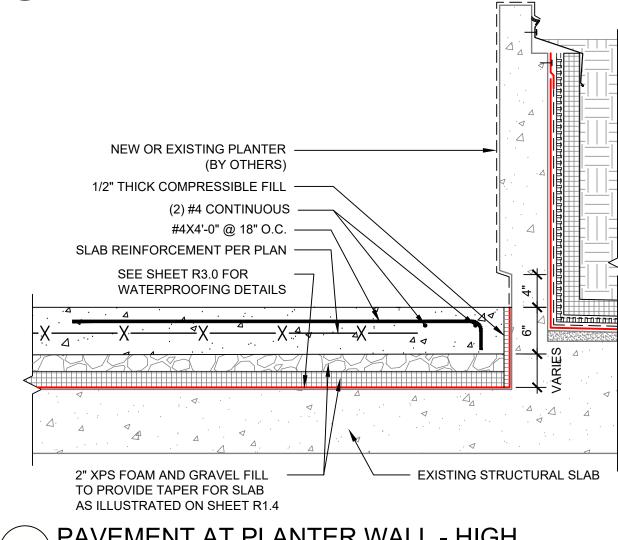

PAVEMENT AT PLANTER WALL - HIGH

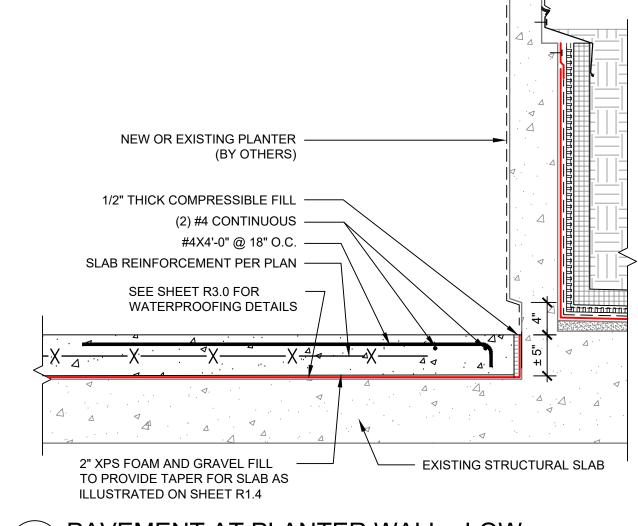

\ PAVEMENT AT PLANTER WALL - LOW

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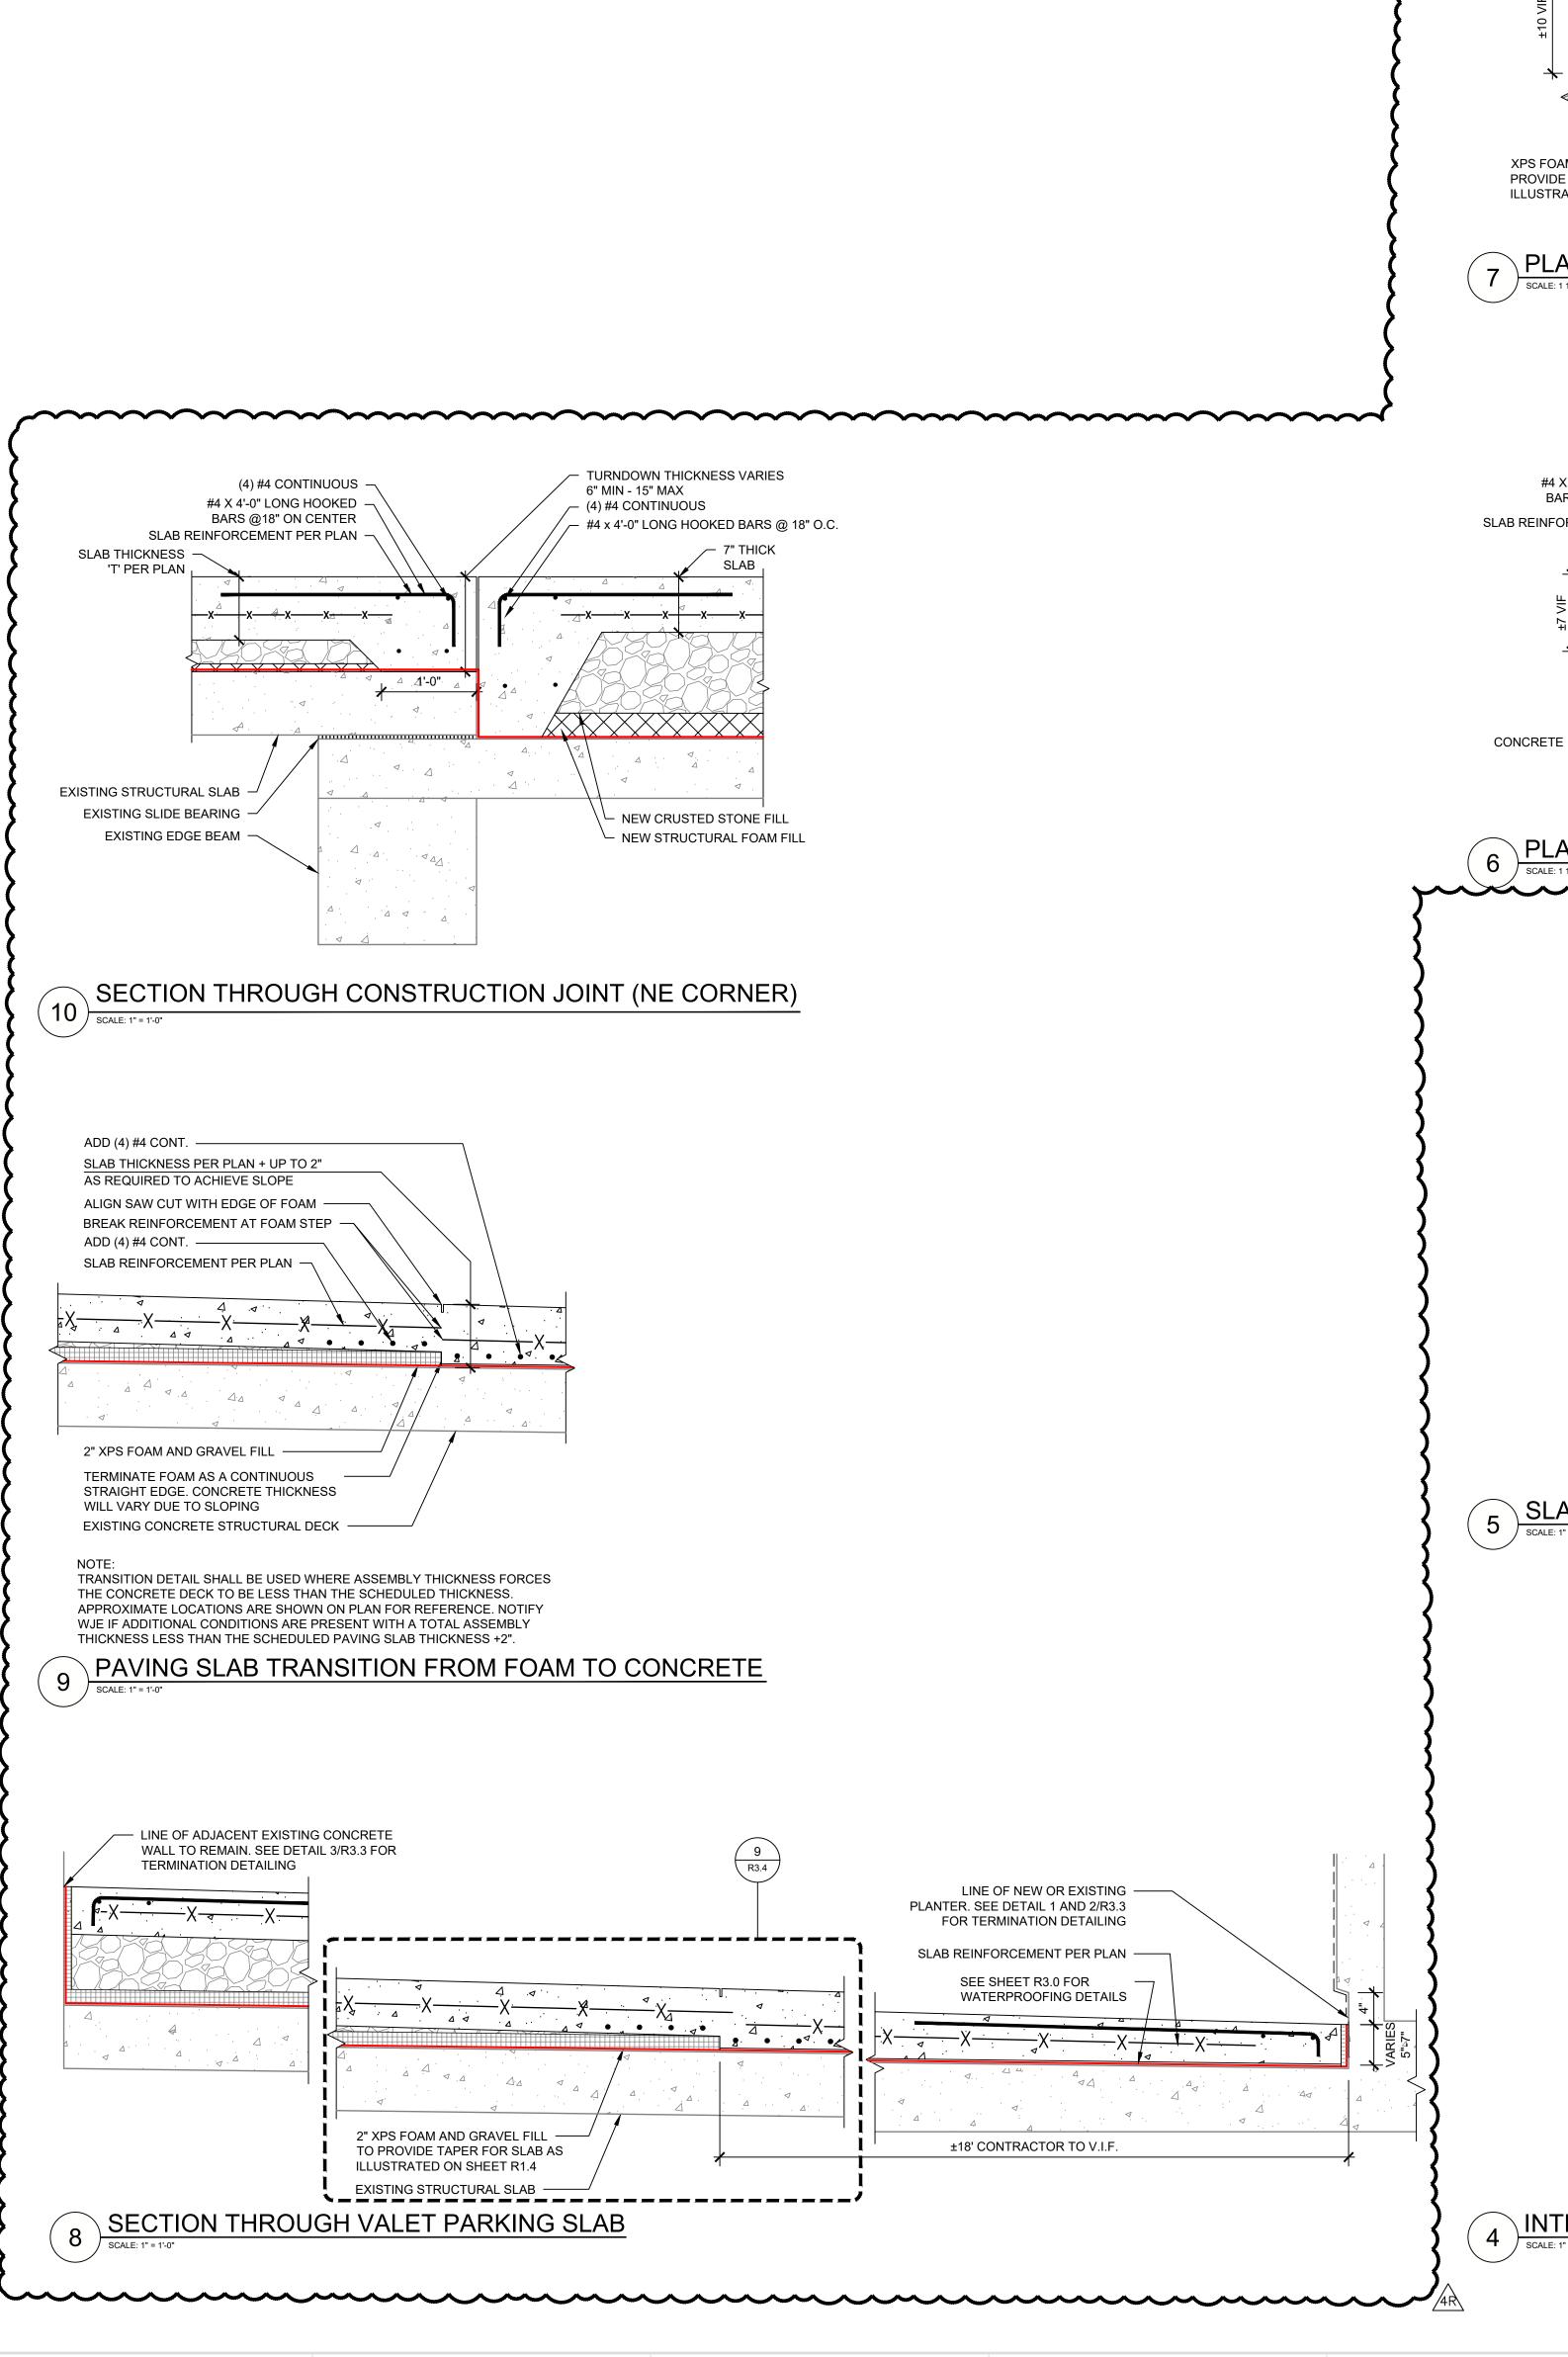
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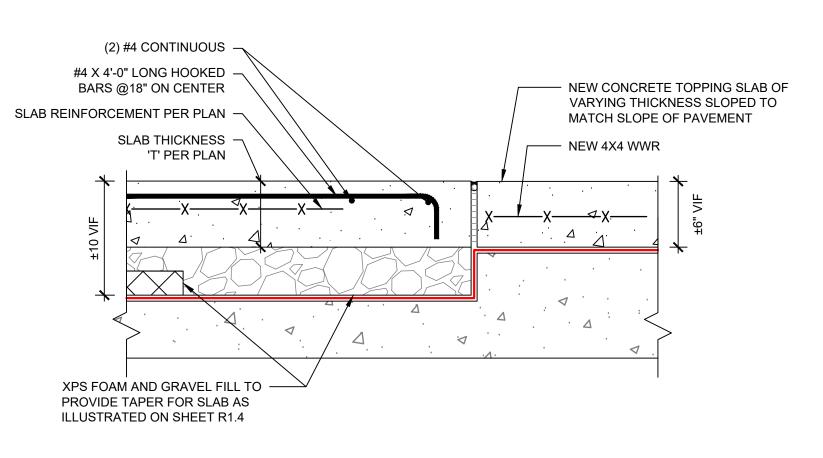
Project No. 2020.7251.1 05/01/2024 RC/EG/RRK Checked CG

> **Concrete Pavement** Details


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Sheet No.






PLANTER STEP - HIGH SIDE

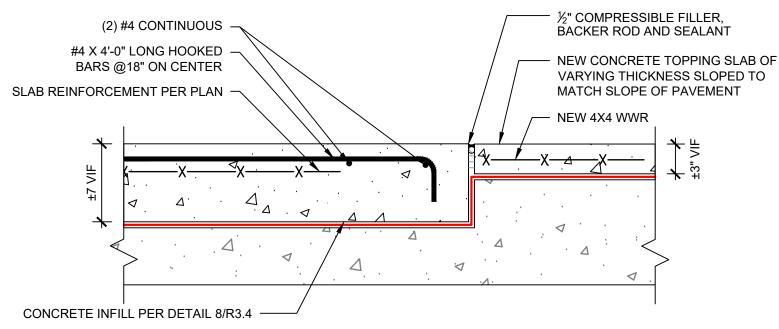


6 PLANTER STEP - LOW SIDE

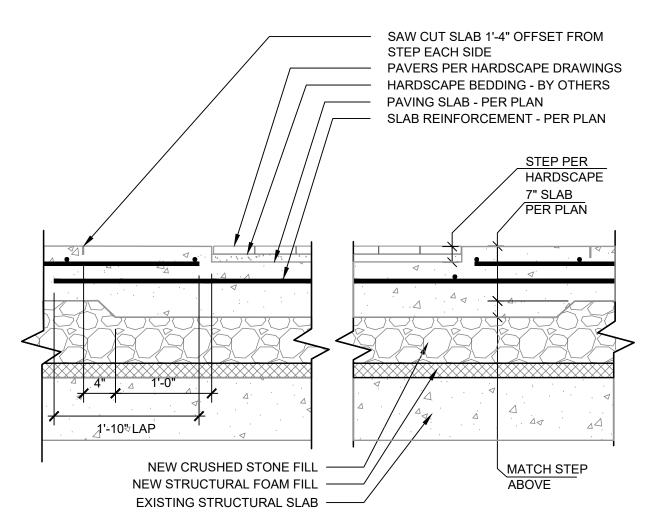


SLAB DEPRESSION AT FLUSH PAVER CONDITION

SCALE: 1" = 1'-0"

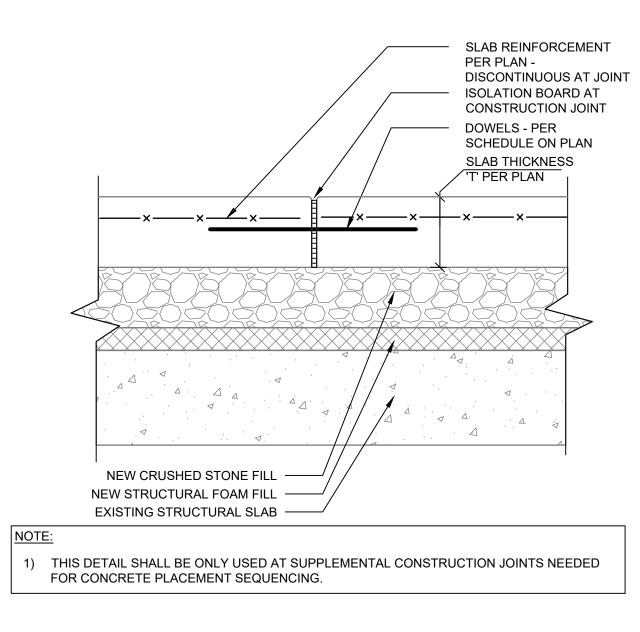


\INTERIOR ISOLATION JOINT

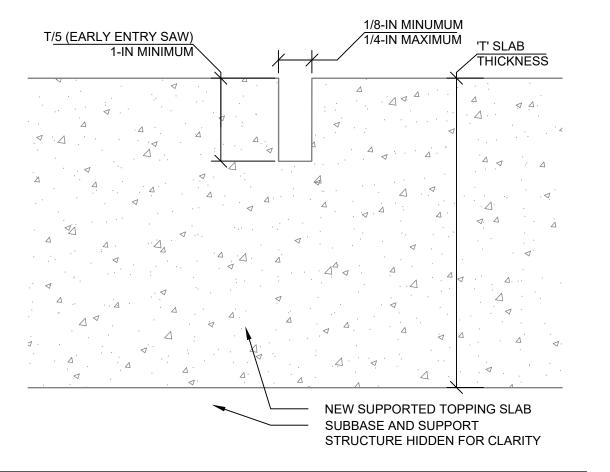


1) EARLY ENTRY SAWS REFER TO SAWS CUTTING CONTROL JOINTS NO MORE THAN 3 HOURS AFTER FINISHING

3 CONTROL JOINT DETAIL

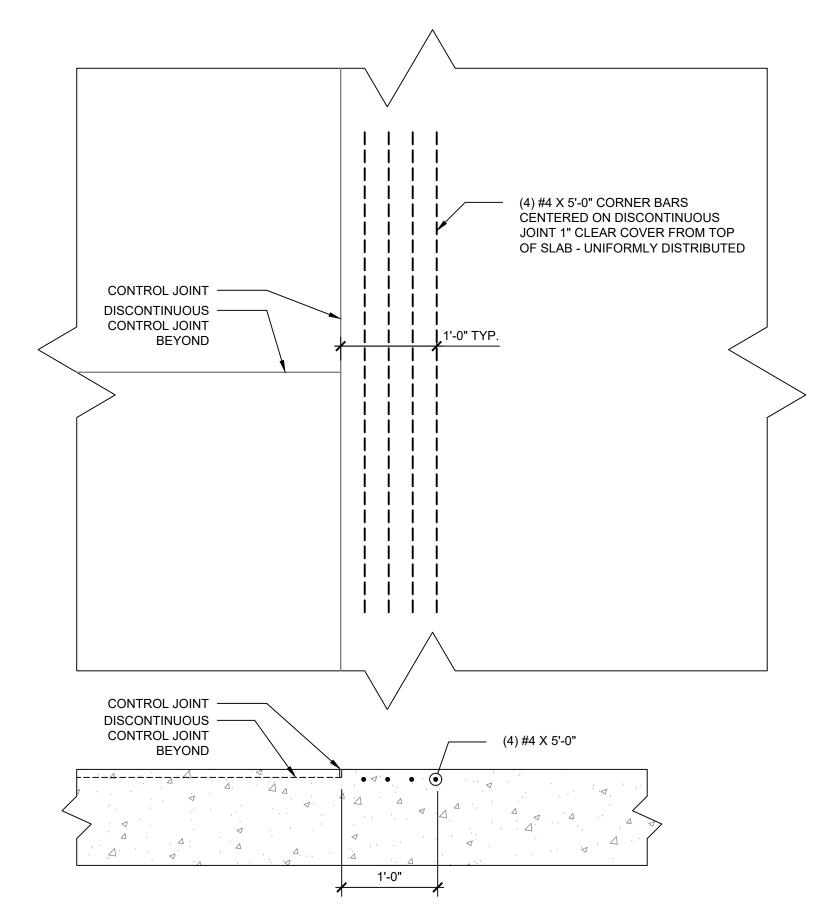

SUPPLEMENTAL REINFORCING AT JOINT TERMINUS

SCALE: 1" = 1'-0"

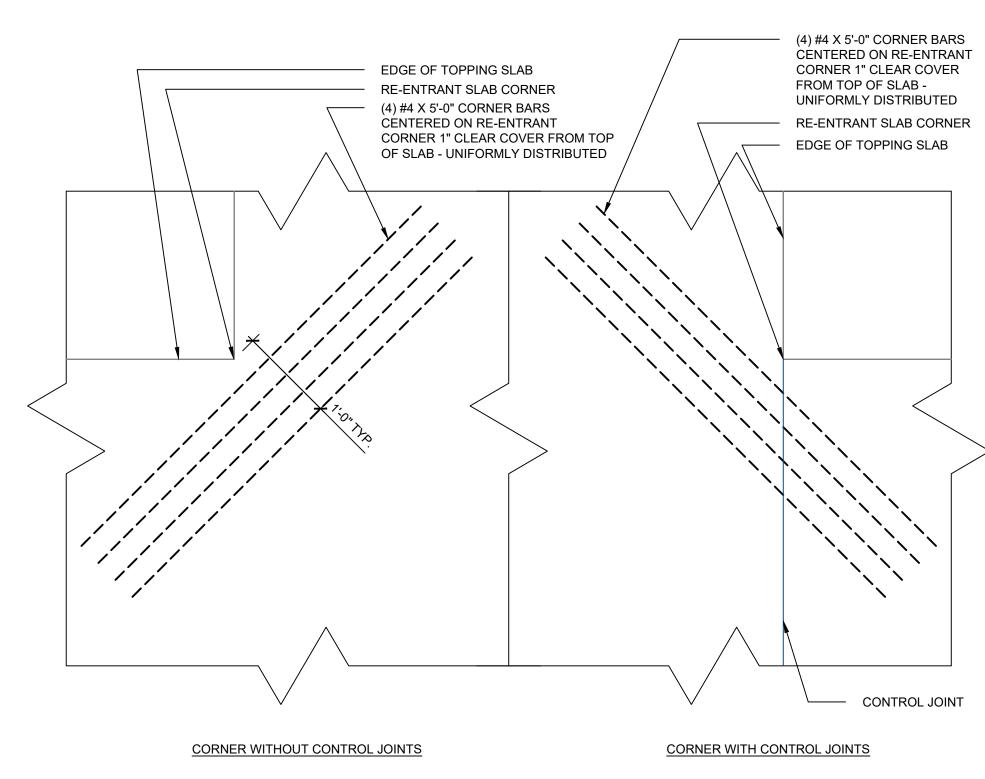

SUPPLEMENTAL REINFORCING AT CORNERS

Wiss, Janney, Elstner Associates, Inc. 2055 Sugarloaf Circle, Suite 250 Duluth, Georgia 30097 770.923.9822 tel www.wje.com

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Consultants

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Park Place on Peachtree **Condominium Association** 2660 Peachtree Rd NE Atlanta, Georiga 30305

4R 07/15/2024 ADDENDUM NO. 4R 06/28/2024 RFI 33 06/19/2024 ADDENDUM NO. 4 05/01/2024 ADDENDUM NO. 3 03/01/2024 ADDENDUM NO. 2 02/12/2024 PERMIT REVISION 01/08/2024 ADDENDUM NO. 1 11/10/2023 ISSUED FOR CONSTRUCTION Mark Date


Project No. 2020.7251.1

RC/EG/RRK Checked CG Scale As Noted

Concrete Pavement

Sheet No.

Details

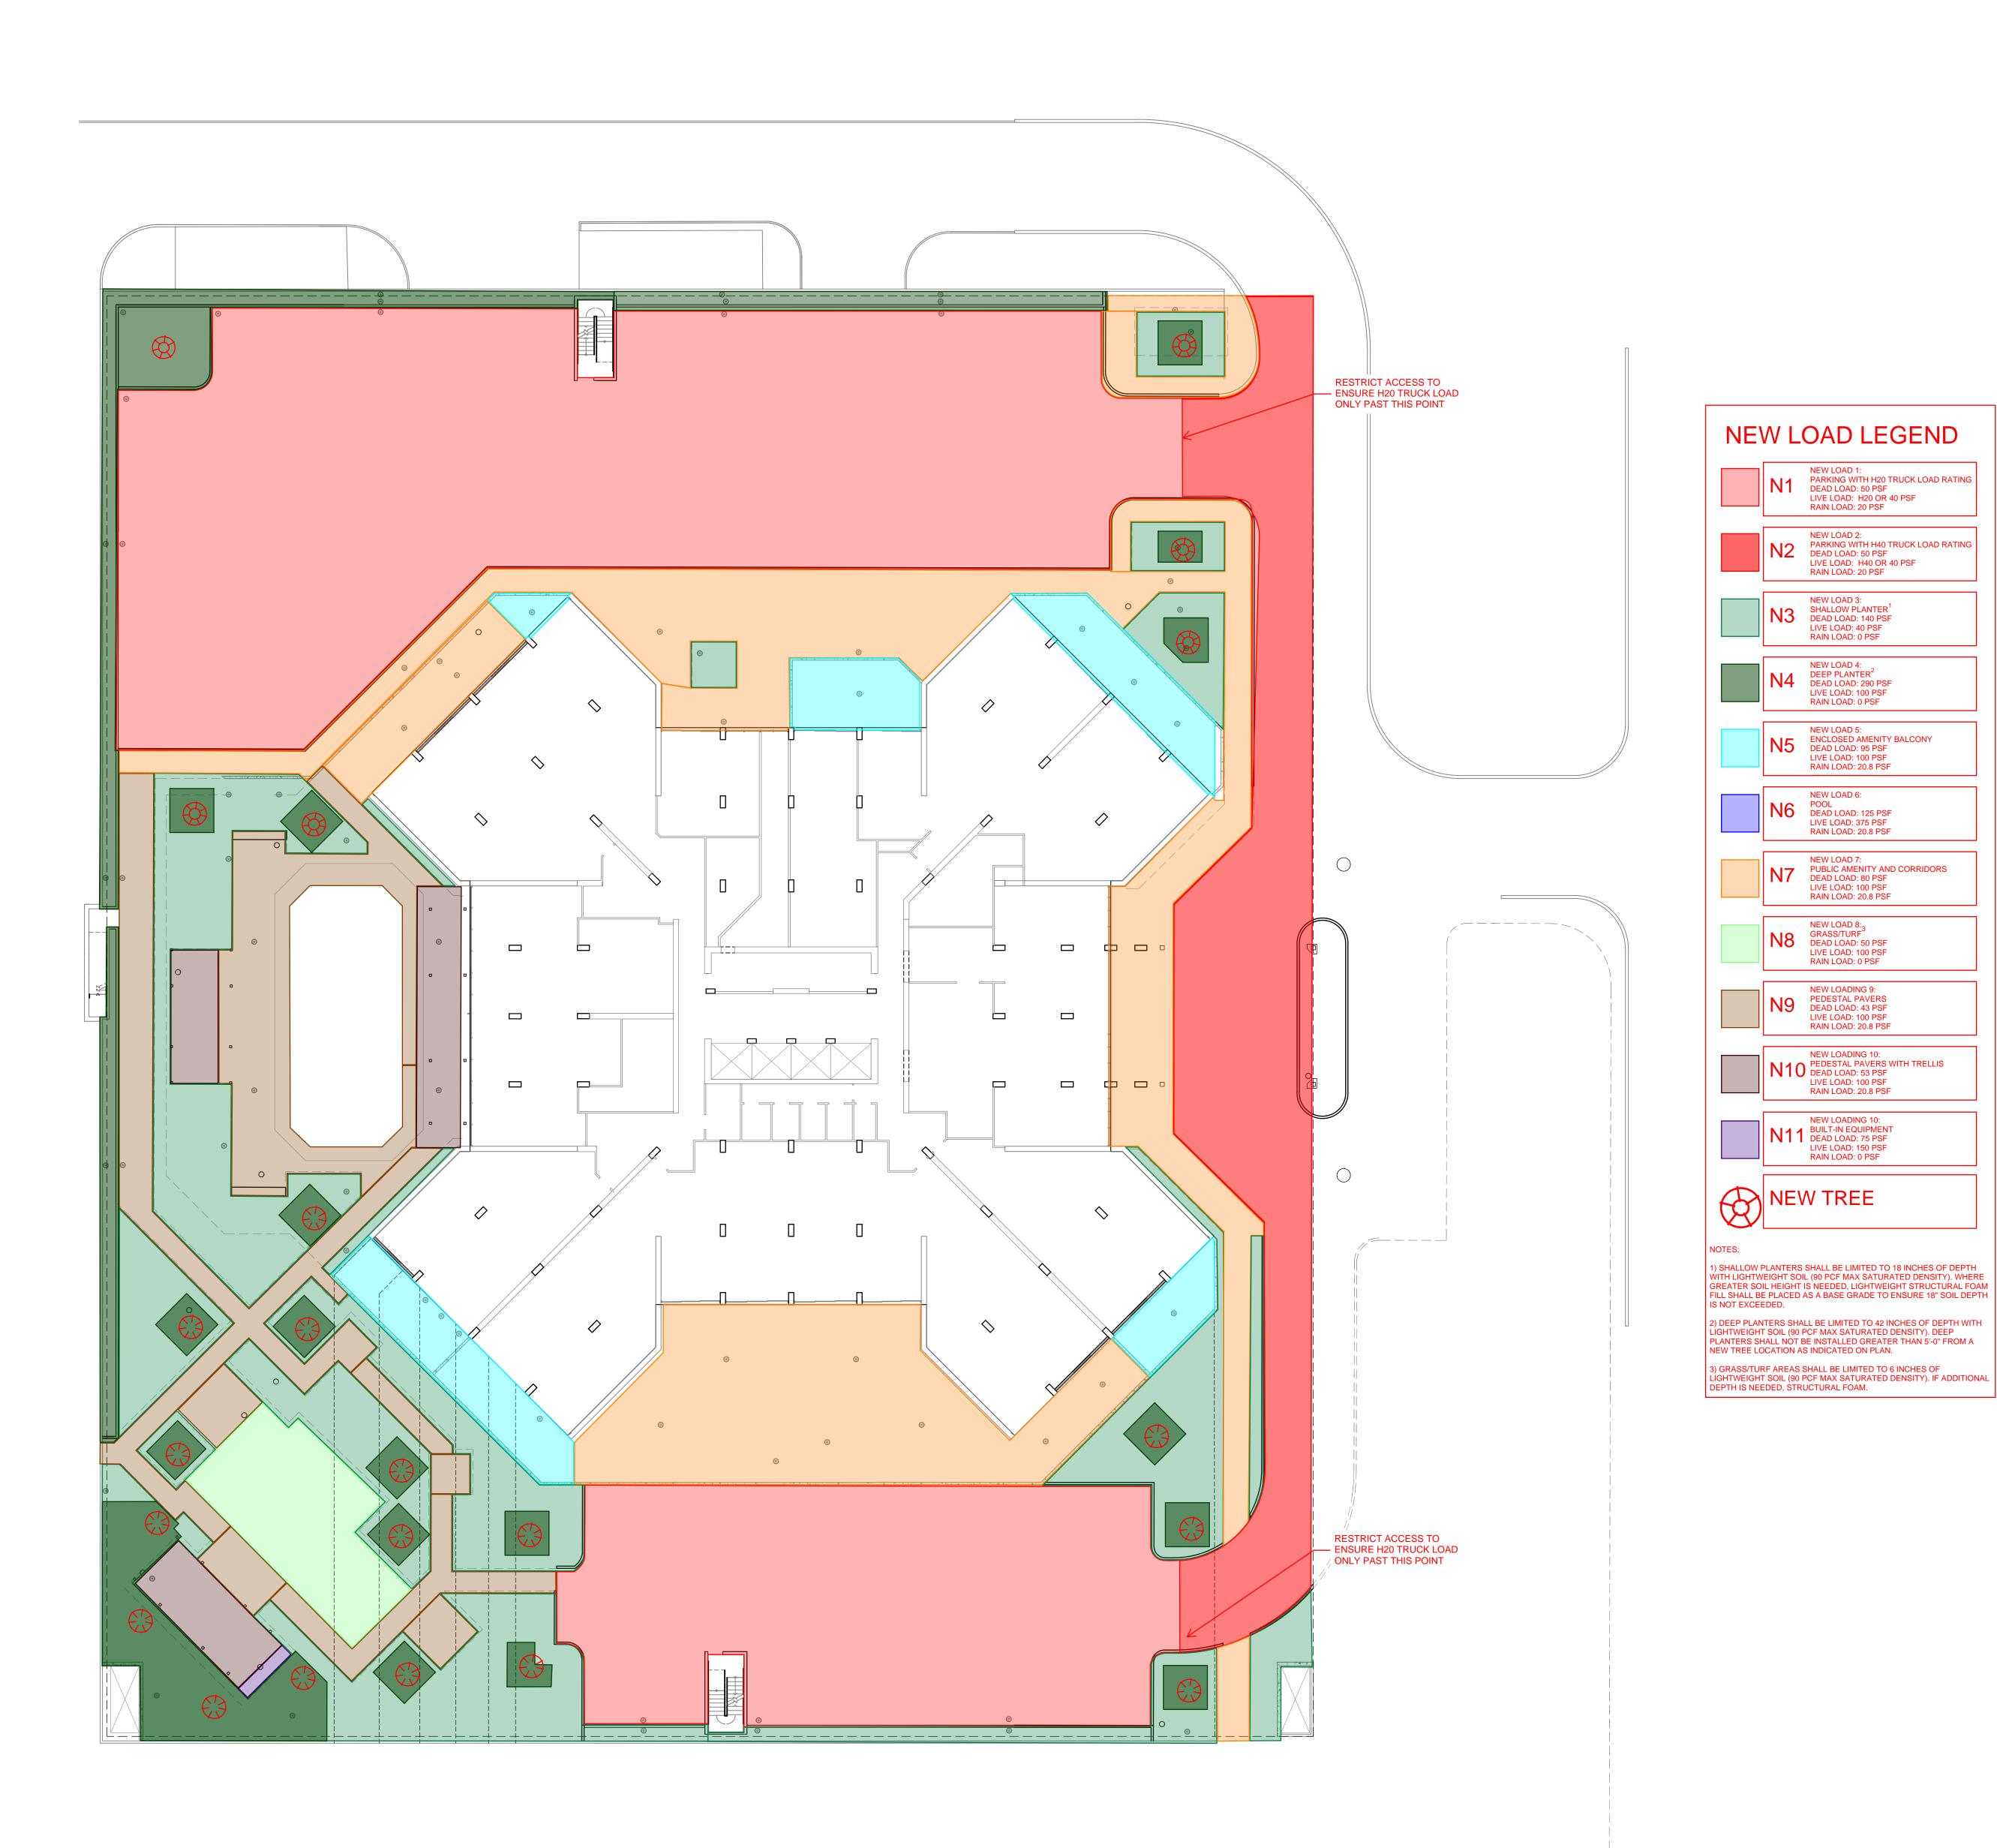

NEW LOADING PLAN

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NEW LOAD 1:
PARKING WITH H20 TRUCK LOAD RATING
DEAD LOAD: 50 PSF
LIVE LOAD: H20 OR 40 PSF
RAIN LOAD: 20 PSF

NEW LOAD 2: PARKING WITH H40 TRUCK LOAD RATING DEAD LOAD: 50 PSF LIVE LOAD: H40 OR 40 PSF RAIN LOAD: 20 PSF

NEW LOAD 3.

SHALLOW PLANTER¹
DEAD LOAD: 140 PSF
LIVE LOAD: 40 PSF
RAIN LOAD: 0 PSF

NEW LOAD 4:
DEEP PLANTER²
DEAD LOAD: 290 PSF
LIVE LOAD: 100 PSF
RAIN LOAD: 0 PSF

N6
POOL
DEAD LOAD: 125 PSF
LIVE LOAD: 375 PSF
RAIN LOAD: 20.8 PSF

NEW LOAD 8:3 GRASS/TURF DEAD LOAD: 50 PSF LIVE LOAD: 100 PSF RAIN LOAD: 0 PSF

N9 PEDESTAL PAVERS DEAD LOAD: 43 PSF

NEW LOADING 10:
BUILT-IN EQUIPMENT
DEAD LOAD: 75 PSF
LIVE LOAD: 150 PSF
RAIN LOAD: 0 PSF

LIVE LOAD: 100 PSF RAIN LOAD: 20.8 PSF

LIVE LOAD: 100 PSF RAIN LOAD: 20.8 PSF

NEW LOADING 10:
PEDESTAL PAVERS WITH TRELLIS
DEAD LOAD: 53 PSF

NEW LOAD 5:
ENCLOSED AMENITY BALCONY
DEAD LOAD: 95 PSF
LIVE LOAD: 100 PSF
RAIN LOAD: 20.8 PSF

NEW LOAD 7:
PUBLIC AMENITY AND CORRIDORS
DEAD LOAD: 80 PSF
LIVE LOAD: 100 PSF
RAIN LOAD: 20.8 PSF

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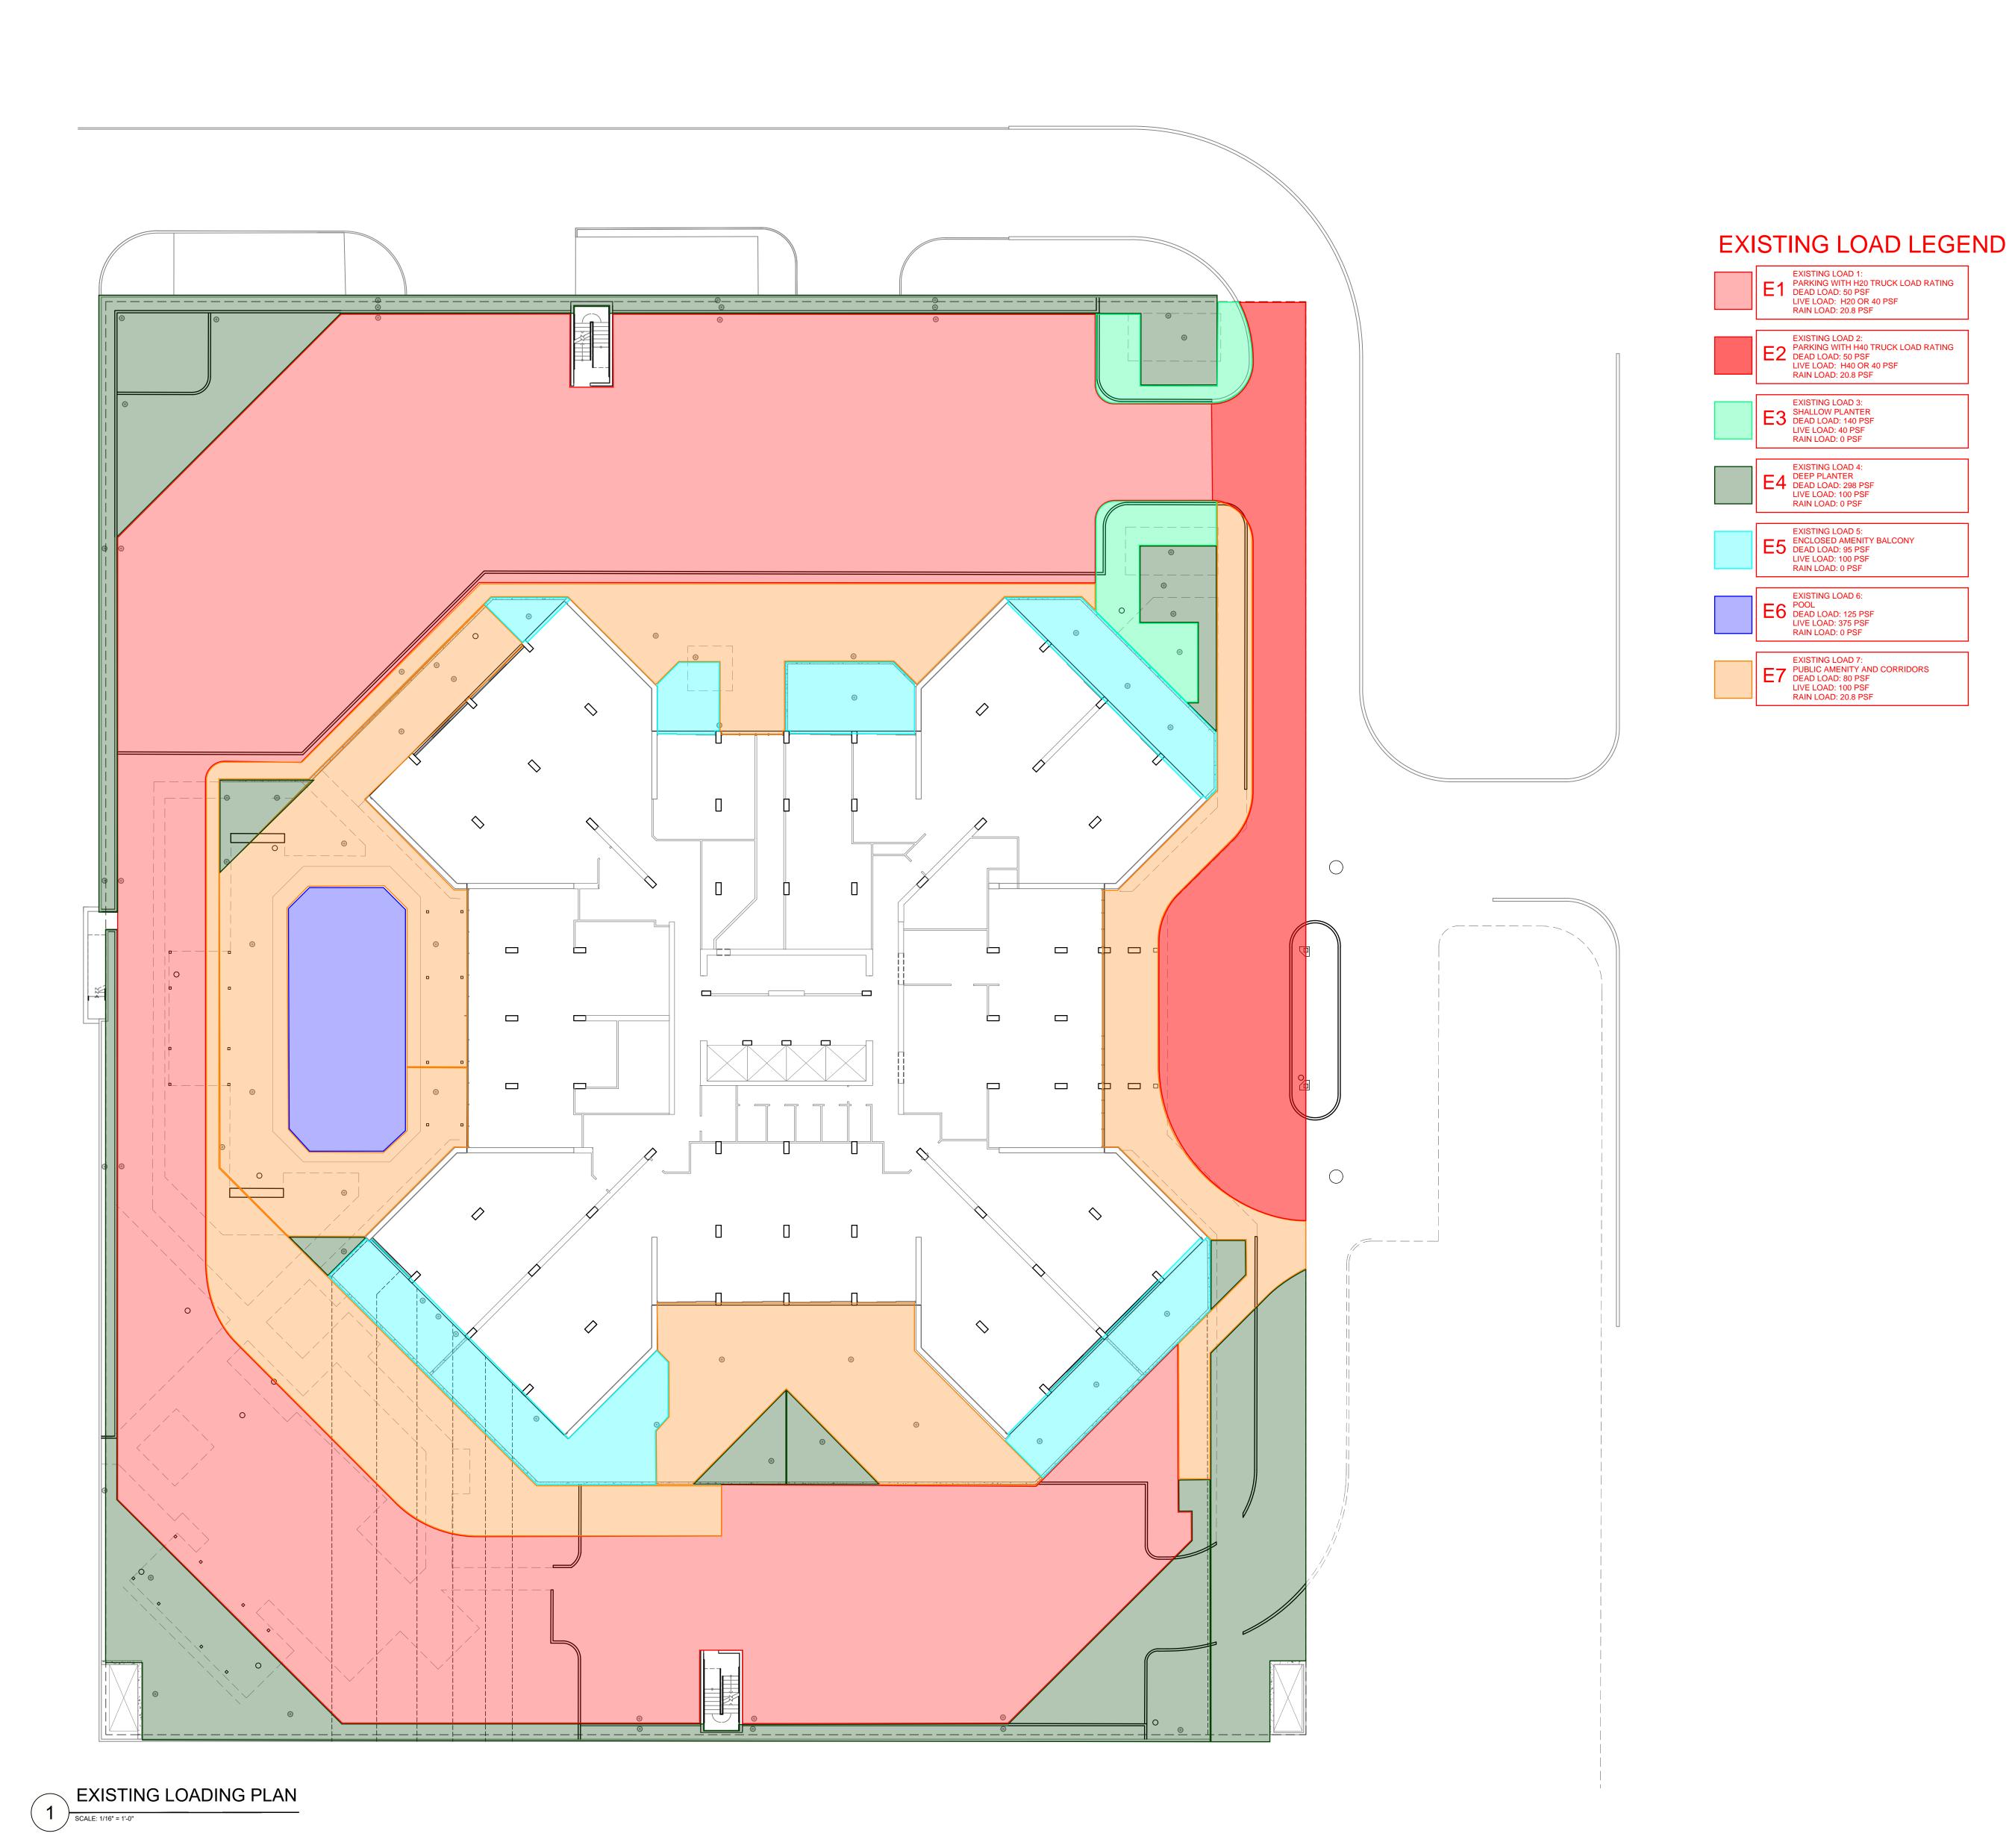
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01/08/2024 ADDENDUM NO. 1 11/10/2023 ISSUED FOR CONSTRUCTION Mark Date

Project No. 2020.7251.1

Plaza Level New Loading

R4.0





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E4 EXISTING LOAD 4:
DEEP PLANTER
DEAD LOAD: 298 PSF
LIVE LOAD: 100 PSF
RAIN LOAD: 0 PSF

LIVE LOAD: 100 PSF RAIN LOAD: 0 PSF

POOL
DEAD LOAD: 125 PSF
LIVE LOAD: 375 PSF
RAIN LOAD: 0 PSF

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03/01/2024 ADDENDUM NO. 2 02/12/2024 PERMIT REVISION 01/08/2024 ADDENDUM NO. 1

11/10/2023 ISSUED FOR CONSTRUCTION Mark Date

Project No. 2020.7251.1

Plaza Level Existing Loading Plan

Sheet No.

R4.1