
PARK PLACE ON PEACHTREE

2660 PEACHTREE ROAD NW ATLANTA, GA 30305

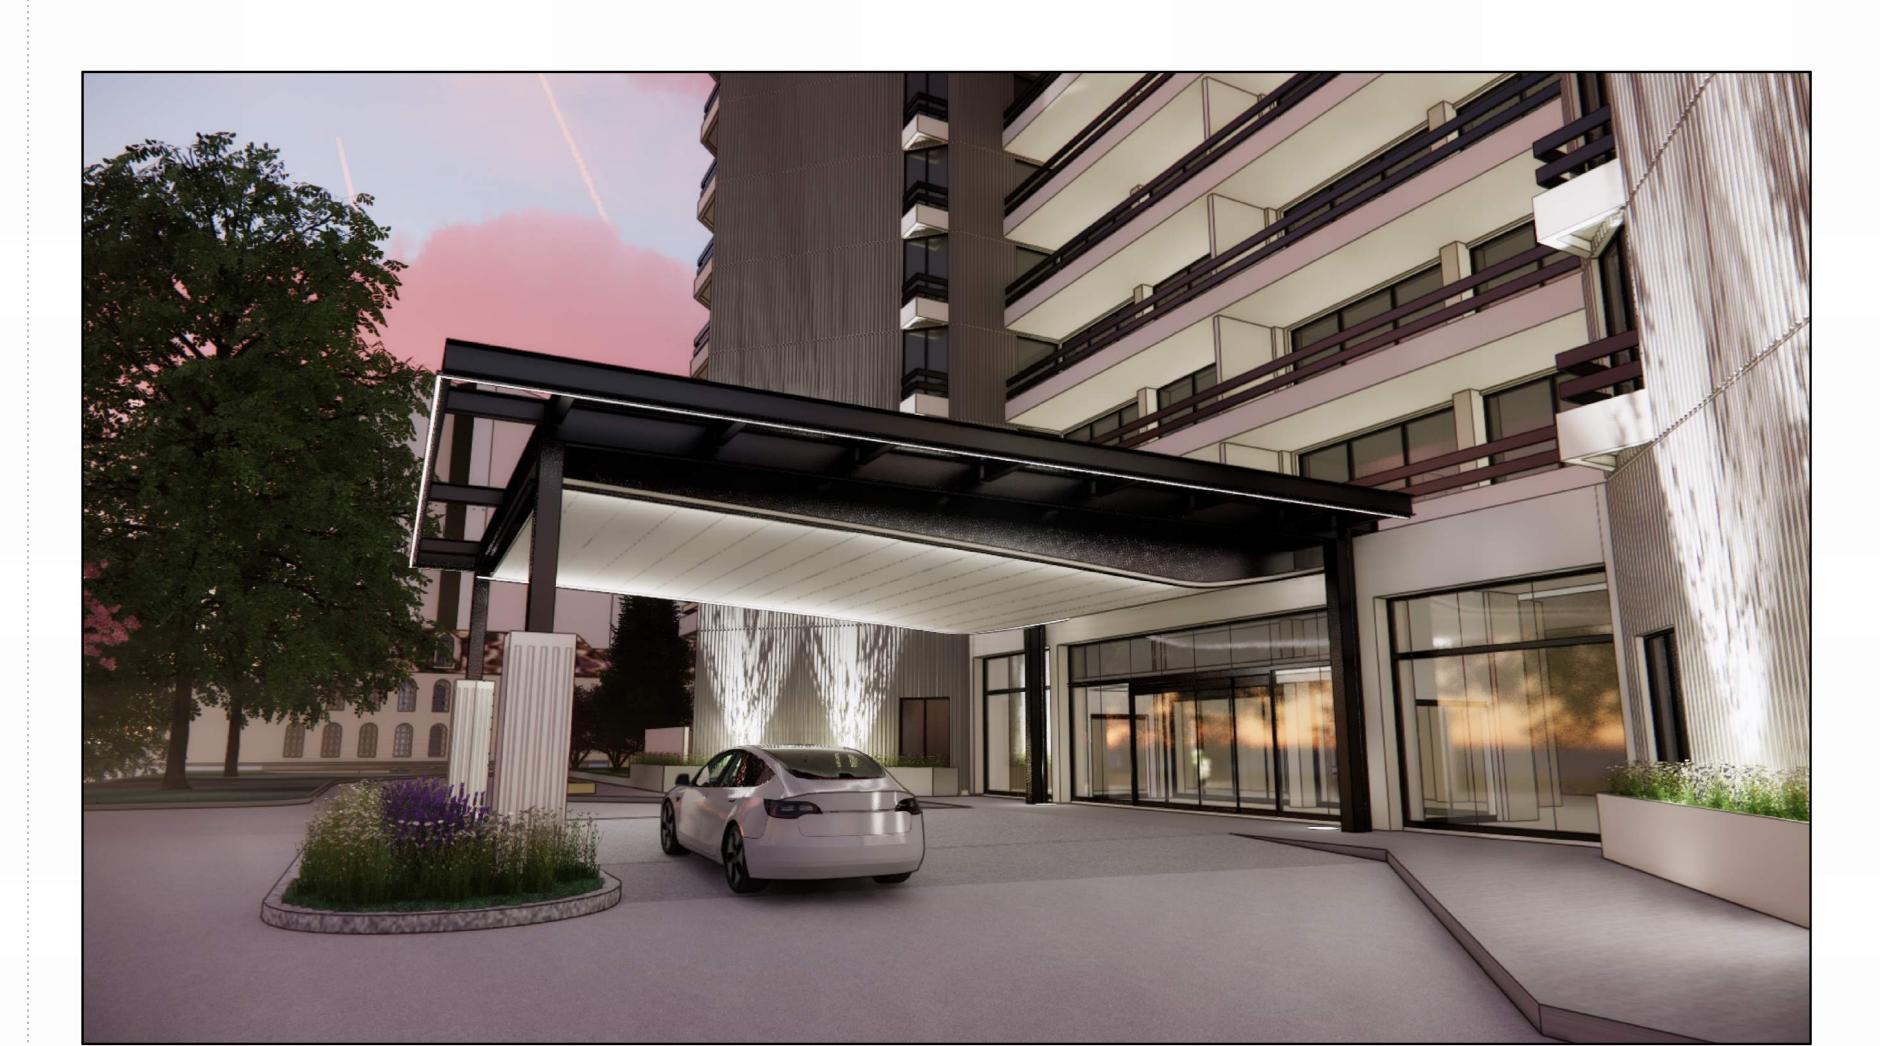

PROJECT SUMMARY

LANDSCAPE PARK PLACE ON PEACHTREE Contact: Tim Huffman Address: 2660 Peachtree Rd. NW voice: (404) 248-1960 Atlanta, GA 30305 email: tfuller@hgor.com voice: (404) 262-2211 STRUCTURAL email: tim@parkplace2660.com WISS, JANNEY, ELSTNER & ASSOCIATES **OWNER'S REPRESENTATIVE** VANDERMEER MANAGEMENT Contact: Robert Kuykendall voice: (770) 923-9822 Contact: Otto Johnson email: rkuykendall@wje.com voice: (404) 556-7835 email: otto@vandermeermgt.com NBP ENGINEERS **ARCHITECT** SMITH DALIA ARCHITECTS Contact: Kevin Smith

PROJECT TEAM

Contact: Brett Bowers

Address: 83 Poplar St. NW

voice: (404) 892-2443 email: bbowers@smithdalia.com

Contact: Alan Wieczynski voice: (770) 483-1173 email: alanw@landplanning.net

LOCATION MAP

BREEDLOVE LAND PLANNING

Atlanta, GA 30303

voice: (478) 745-1691 email: ksmith@nbpengineers.com WATERPROOFING

WISS, JANNEY, ELSTNER & ASSOCIATES Contact: Eric Gross voice: (770) 923-9822 email: egross@wje.com

PEACHTREE ROAD NW


Park Place is a forty-story, concrete framed building that was constructed in the early 1980s. The building consists of condominium units on the upper forty floors and three levels of partially below-grade parking, with a plaza level topping the parking structure. The building is primarily clad with precast concrete panels and has aluminum-framed storefront systems installed at the entrance to the building. The porte cochere structure is connected to the storefront systems and is supported by the building to the west and four columns to the east, spanning over the elevated plaza. The structure of the porte cochere measures approximately 48 feet by 30 feet in plan dimensions. The existing porte cochere is clad with stucco on the columns, faces, and soffit, and has a low-slope roof assembly with

This project scope consists of a new porte cochere to replace the original 1980s era construction, with the intent to utilize the existing below-grade structure as its support and maintain the same approximate footprint. The original slanted glass storefront will be removed and replaced with a new storefront system to match the recently renovated sliding glass entry. The sliding glass entry will be maintained to save costs. The new porte cochere construction consists of a steel moment frame with suspended metal composite

Design and construction of the new porte cochere is to be generally concurrent with the site redevelopment and plaza deck waterproofing projects being performed by HGOR and WJE, respectively.

SHEET	Γ INDEX		1	
Sheet Number	Sheet	Name	Issue Date	Current Revision
ARCHITE		14amo	100d0 Date	٠ ١ ١ ١ ١ ١ ١ ١
A000	COVER / SITE PL	_AN	10/31/23	3
A001	GENERAL NOTE	S	10/31/23	2
A020	DEMOLITION PLA	ANS	10/31/23	2
A100	PLANS		10/31/23	2
A200	RCP		10/31/23	3
A300	SECTIONS & ELE	EVATIONS	10/31/23	3
A500	ENVELOPE DETA	AILS	10/31/23	3
A501	PORTE COCHER	RE DETAILS	10/31/23	2
A502	GLAZING DETAIL	_S	10/31/23	2

PROJECT DATA / CODE

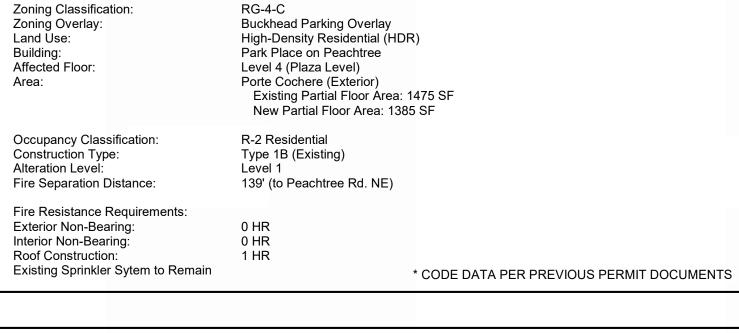

STATE OF GEORGIA APPLICABLE CODES (2023):


International Plumbing Code, with GA Amendments 2020
International Plumbing Code, with GA Amendments 2020, 2022
National Electrical Code with GA Amendments 2021
International Energy Conservation Code w/ Georgia State Supplements and Amendments 2020, 2020 IPC 2018 NFPA (101) 2018 Life Safety Code with 2020 Georgia State Fire Commissioner Amendments 120-3-3-.04(72)

Americans with Disabilities Act (ADA) - 2010 ADA Standards for Accessible Design (ADAAG)

PORTE COCHERE CONSTRUCTION DOCUMENTS

SDA

 ceiling. Clarification of L-9 canopy light fixture mounting at ACM. A300 – Addition of owner requested exterior power outlets for holiday wreath A500 - Addition of new owner requested exterior power outlets for holiday wreath. Electrical 	Glenn Grosse (SDA) Glenn Grosse (SDA) Robert Vandermeer (Vandermeer) Otto Johnson (Vandermeer) Tim Huffman (PPoP) Bryan Cooke (PPoP) Clarence Solodkin (HGOR) overs the revisions described below and includes the following sheets (attached). rchitectural (Porte Cochere) A000 – Sheet Index - Drawing revision update. A200 – Interior soffit clarification and addition of owner requested light fixtures at lobby ceiling. Clarification of L-9 canopy light fixture mounting at ACM. A300 – Addition of owner requested exterior power outlets for holiday wreath. A500 - Addition of new owner requested exterior power outlets for holiday wreath.	То:	Gay Construction Company	Project:	Park Place on Peachtre		
Attachments: (see below) Cc: Robert Vandermeer (Vandermeer) Otto Johnson (Vandermeer) Tim Huffman (PPoP) Bryan Cooke (PPoP) Clarence Solodkin (HGOR) nis ASI covers the revisions described below and includes the following sheets (attached). Architectural (Porte Cochere) A000 – Sheet Index - Drawing revision update. A200 – Interior soffit clarification and addition of owner requested light fixtures at lot ceiling. Clarification of L-9 canopy light fixture mounting at ACM. A300 – Addition of owner requested exterior power outlets for holiday wreath. Electrical	Robert Vandermeer (Vandermeer) Otto Johnson (Vandermeer) Tim Huffman (PPoP) Bryan Cooke (PPoP) Clarence Solodkin (HGOR) overs the revisions described below and includes the following sheets (attached). rchitectural (Porte Cochere) A000 – Sheet Index - Drawing revision update. A200 – Interior soffit clarification and addition of owner requested light fixtures at lobby ceiling. Clarification of L-9 canopy light fixture mounting at ACM. A300 – Addition of owner requested exterior power outlets for holiday wreath. A500 - Addition of new owner requested exterior power outlets for holiday wreath. E202 – Addition of owner requested interior light fixtures at lobby ceiling and			•			
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·	exterior power outlets for holiday wreath.	•	ceiling. Clarification of L-9 canopy li A300 – Addition of owner reques A500 - Addition of new owner re wreath.	ght fixture mounting at A sted exterior power out	CM. lets for holiday wreath.		

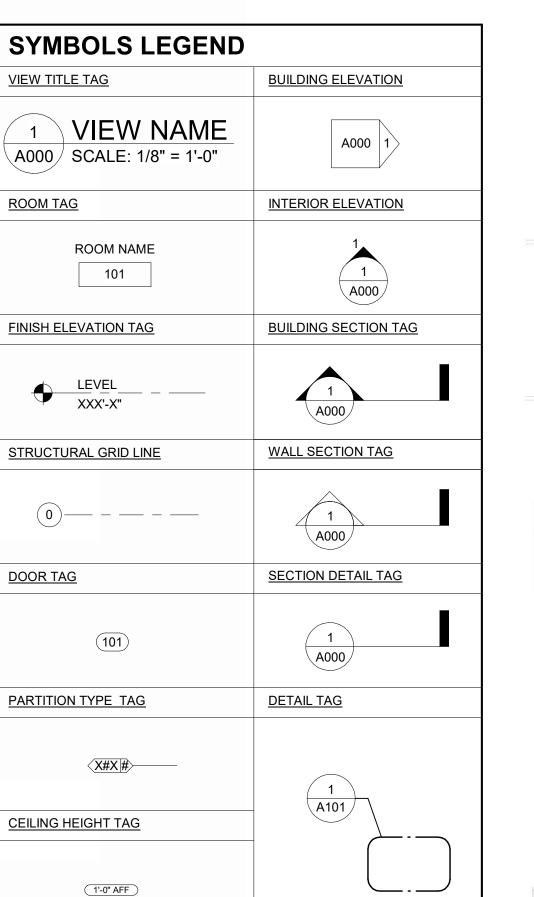


VIEW TITLE TAG

DOOR TAG

Climate Zone:3		
Item:	Required:	Provided:
Roofs:	R-25ci	R-25ci
Walls:	D 40 - D 7 5 '	D 40 - D 7 5 -
Above Grade:	R-13 + R 7.5ci	R-19 + R 7.5ci
Below Grade:	NR	N/A
Floors:		
Elevated:	R-30	N/A
Slab-on-grade:	NR	NR
Doors:		
Opaque:	U-0.61	N/A
Entrance:	U-0.77	N/A
Fixed Fenestration:	U-0.46	U-0.46
SHGC:	0.25	0.25


SITE PLAN


A000 SCALE: 1" = 30'-0"

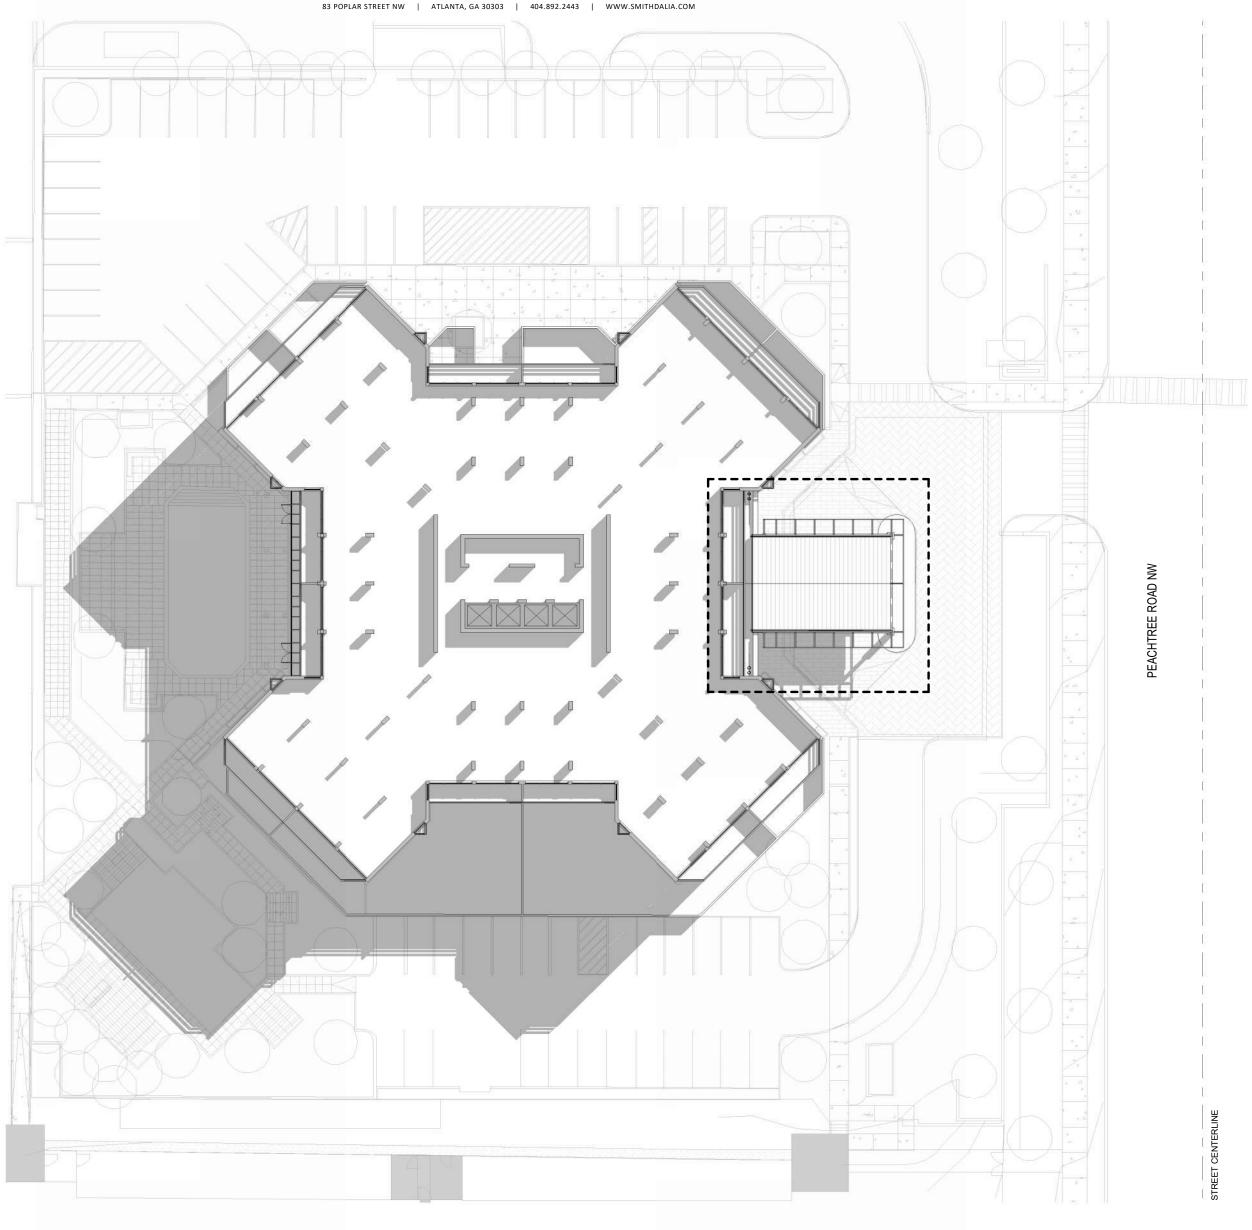


AREA OF WORK

4/22/2024 10:50:59 AM Construction Documents OCTOBER 31, 2023 1 12/15/23 ADDENDUM 1 2 02/12/24 PERMIT REVISION 3 04/18/24 ASI #01

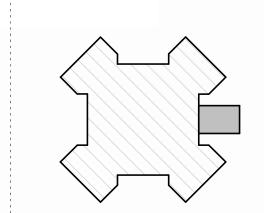

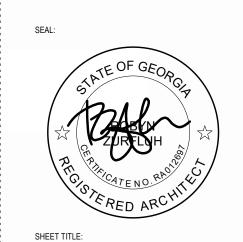

COVER / SITE PLAN

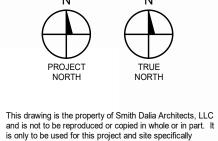

identified herein. CADD and BIM Model information must be ascertained and verified through actual element properties and comparison with hard copy information. A000

GENERAL NOTES

1. SCOPE OF THESE DRAWINGS IS INTENDED FOR BUILDING EXTERIOR ALTERATIONS ONLY AND HAVE NO IMPACT ON THE ORIGINALLY PERMITTED BUILDING WITH RESPECT TO LIFE SAFETY, BUILDING CONSTRUCTION TYPE, OCCUPANCY, ALLOWABLE HEIGHT AND AREA, ETC. SEE PROJECT DATA / CODE TABLE ON COVER SHEET FOR EXISTING BUILDING CODE INFORMATION.
2. ALL DRAWINGS AND DIMENSIONS ARE BASED ON AUGUST 20TH, 1987 AS-BUILT DRAWINGS. REFER TO AS-BUILT DRAWINGS FOR BASE BUILDING ARCHITECTURAL COMPONENTS.
3. CONTRACTOR SHALL VERIFY ALL DIMENSIONS IN-FIELD AND REPORT ANY DISCREPANCIES TO THE ARCHITECT.

4. ALL WORK SHALL BE PERFORMED IN STRICT ACCORDANCE WITH ALL APPLICABLE BUILDING CODES AND LOCAL ORDINANCES.
5. THE CONTRACTOR SHALL BE RESPONSIBLE FOR SECURING AND PAYING FOR ALL REQUIRED PERMITS, INSPECTIONS, FEES, ETC.

6. THE CONTRACTOR SHALL BE RESPONSIBLE FOR ANY DAMAGE TO THE BUILDING OR ANY OTHER PROPERTY WHICH MAY OCCUR DURING CONSTRUCTION.
7. THE CONTRACTOR SHALL NOTIFY THE ARCHITECT OF ANY INCONSISTENCIES OR DISCREPANCES DISCOVERED BETWEEN ACTUAL SITE CONDITIONS AND THOSE INDICATED ON THE

DRAWINGS THAT WOULD AFFECT THE QUALITY OF THE WORK.

8. THE CONTRACTOR SHALL VERIFY ALL DIMENSIONS INDICATED ON THE DRAWINGS AND REPORT ANY DISCREPANCIES TO THE ARCHITECT.

9. IN THE EVENT OF A CONFLICT OR OMISSION BETWEEN THE ARCHITECTS OR ENGINEERS DRAWINGS AND THE ACCESSIBILITY STANDARDS REQUIREMENTS, THE LATEST ADOPTED EDITIONS
OF THE PUBLISHED ADA STANDARDS WILL TAKE PRIORITY.

10. WHERE NEW PARTITIONS ARE BUILT TO ALIGN WITH ONE SIDE OF A WALL, STUD SHALL ALIGN SO THE GYPSUM BOARD WILL BE CONTINUOUS ACROSS STUDS AND/OR FACE OF FURRING
CHANNELS. PARTITIONS NOTED TO ALIGN SHALL BE ALIGNED FROM FINISH FACES AND THE JUNCTIONS SHALL BE FLUSH AND SMOOTH.

11. ALL FASTENING AND ATTACHMENT SHALL BE FULLY CONCEALED FROM VIEW, UNLESS NOTED OTHERWISE (U.N.O.).

13. INSULATION MATERIALS SHALL COMPLY WITH IBC 719.3 AND 2603.3, AND IEBC TABLE C402.1.2. INSULATING MATERIALS SHALL HAVE A FLAME SPREAD INDEX OF NOT MORE THAN 25 AND A SMOKE-DEVELOPED INDEX OF NOT MORE THAN 450.

14. BASE BUILDING SPECIFICATIONS SHALL APPLY AS A MINIMUM STANDARD. WHERE NOTED OTHERWISE, PROVIDE UPGRADED SPECIFICATIONS.

15. EXISTING MECHANICAL, PLUMBING, ELECTRICAL, AND FIRE PROTECTION COMPONENTS WILL NEED TO BE COORDINATED WTH ALTERATION WORK. CONTRACTOR TO ENSURE THERE ARE

16. PROVIDE SPRING SUSPENDED GYPSUM BOARD WITH TWO LAYERS GYPSUM BOARD AND SOUND ATTENUATION BATTS AT INTERIOR CEILING TO MATCH EXISTING. 17. PROVIDE SEALANT AT TOP, BOTTOM, AND PERIMETER OF ALL WALLS.

12. CONTRACTOR SHALL PROVIDE AND LOCATE BLOCKING IN PARTITIONS WHERE REQUIRED TO SUPPORT HUNG COMPONENTS AS INDICATED IN DRAWINGS.

18. SEAL ALL PENETRATIONS FOR SOUND AND FIRE.19. GALVANIZE AND PAINT ALL EXPOSED STEEL MEMBERS.

20. ALL PERMANENTLY EXPOSED STRUCTURAL STEEL TO BE AESS LEVEL 1.
21. CONTRACTOR TO PROVIDE FINISH SAMPLES OF ALL SPECIFIED MATERIALS FOR REVIEW AND APPROVAL BY OWNER AND ARCHITECT. PROVIDE SUBMITTALS AND SHOP DRAWINGS PER SPECIFICATIONS.

SMITH DALIA

MEMORANDUM

Bert van der MeerProject:Park PlaceVandermeer Management, LLCSDA Project No:22020via emailDate:12/20/2023

From: Brett Bowers

SDA

Subject: Revision Narrative – Addendum #1

The following is a general summary of the Architectural revisions between Construction Document issuance dated 10/31/2023 and Addendum #1 dated 12/15/2023 for Park Place on Peachtree. See revised A-series sheets for all changes; only revisions that include scope changes have been clouded.

Porte Cochere Updates:

A502

A000 - Updated Sheet Index revision number.

- Updated note for columns 4/A.01 & 6/A.01 per structural coordination comments.

A200 - Added security camera locations per security coordination.

- Note to provide AESS at all permanently exposed structural steel added per structural coordination comments and RFP RFI responses.

coordination comments and KFP KFI responses.

A300 - Added security camera locations per security coordination.

A500 - Steel decking graphic revised per structural coordination comments.

- Note to provide AESS at all permanently exposed structural steel added per structural coordination comments and RFP RFI responses.

- Updated note for columns 4/A.01 & 6/A.01 per structural coordination comments.

General - Spelling and note legibility corrections.

PROJECT NO:
22020
Park Place

83 Poplar Street NW

ATLANTA, GA 30303 404.892.2443 voice

mail@smithdalia.com

CONSULTANT:

Park Plac

PARK PLACE ON PEACHTRE
PORTE COCHERE
2660 Peachtree Road NW, Atlanta, GA 30305

PLOT DATE:


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ISSUE AND DATE:

Construction Documents

OCTOBER 31, 2023


1 12/15/23 ADDENDUM 1




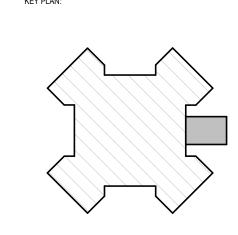

GENERAL NOTES


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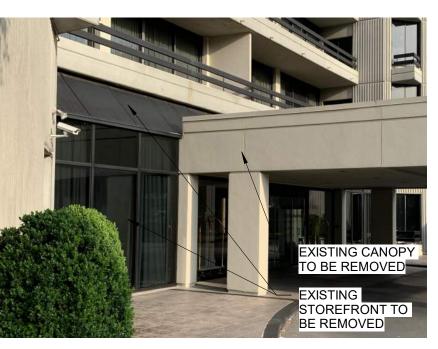


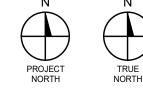


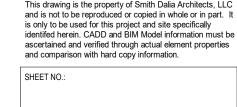A001

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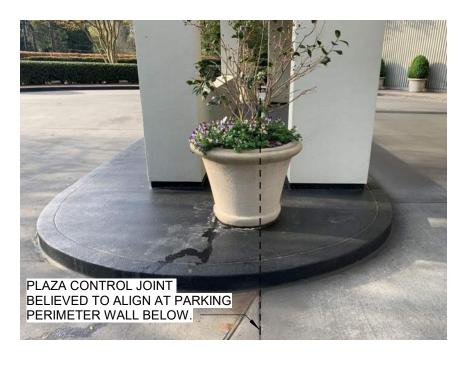


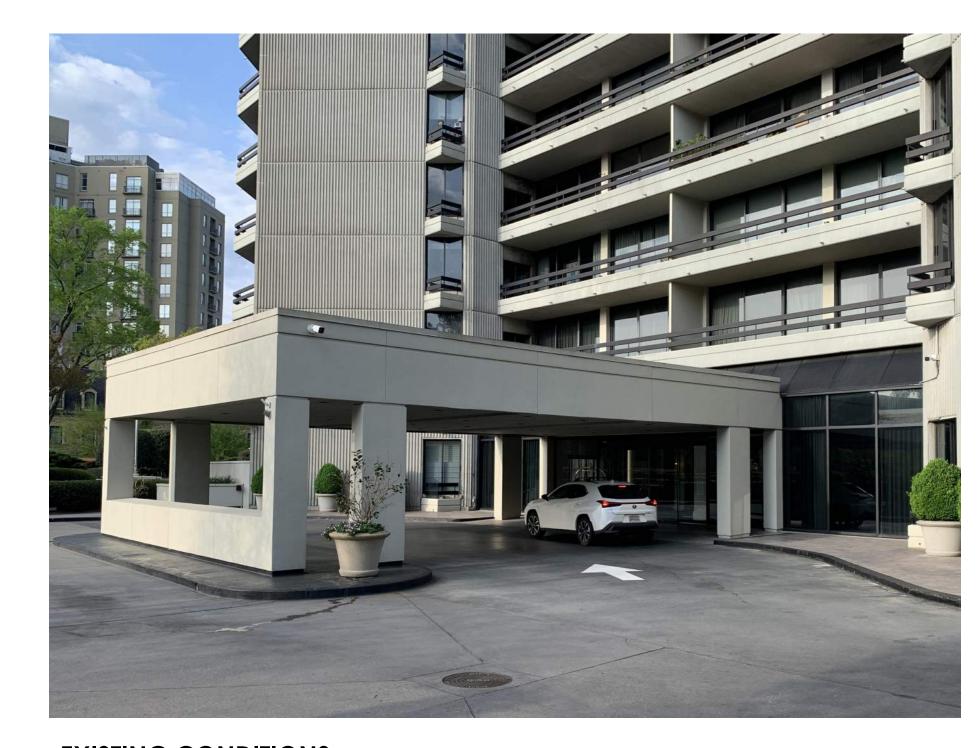


— EXISTING STOREFRONT

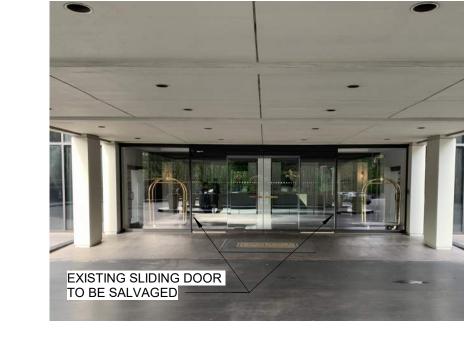TO BE REMOVED

ALIGN WITH NEW SOFFI



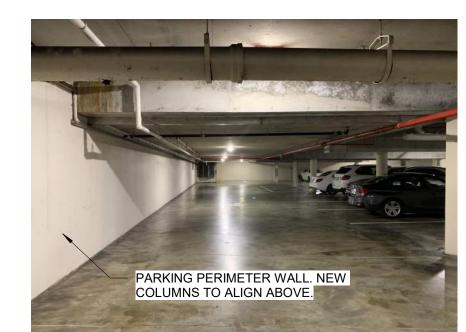


DEMO GENERAL NOTES


- 1. REFER TO 02/27/23 WJE PORTE COCHERE STRUCTURAL ASSESSMENT REGARDING EXISTING STRUCTURE. 2. DEMOLITION INDICATED ON DRAWINGS IS INTENDED TO SHOW LOCATIONS AND GENERAL SCOPE OF DEMOLITION. THE FULL EXTENT OF DEMOLITION REQUIRED TO ACCOMODATE NEW CONSTRUCTION AND SPECIFIED FINISHES MUST BE DETERMINED BY THE CONTRACTOR BASED ON THE FULL CONTRACT DOCUMENTS AND THE SITE CONDITIONS. CONTACT THE ARCHITECT
- WITH ANY QUESTIONS REGARDING THE REQUIRED DEMOLITION SCOPE. 3. CONTRACTOR IS RESPONSIBLE FOR SITE CONDITIONS. BY SUBMITTING A BID FOR THIS WORK THE CONTRACTOR AGREES THAT HE HAS PERFORMED A THOROUGH FIELD INVESTIGATION AND HAS NO QUESTIONS REGARDING SITE CONDITIONS THAT WILL EFFECT THE COST OF DEMOILITION.
- 4. ANY DISCREPANCIES BETWEEN ENCOUNTERED FIELD CONDITIONS AND THESE DRAWINGS SHALL BE REPORTED IMMEDIATELY TO THE ARCHITECT. 5. IF SUSPECTED HAZARDOUS MATERIALS ARE ENCOUNTERED, NOTIFY OWNER AND ARCHITECT IMMEDIATELY. AVOID DISTURBING SUSPECT MATERIALS UNTIL THE COMPOSITION OF SUCH MATERIALS CAN BE CONFIRMED BY AN APPROVED
- TESTING AGENCY. 6. ITEMS INDICATED TO BE DEMOLISHED SHALL BE DISPOSED OF OFF-SITE IN A LEGAL MANNER. ITEMS INDICATED TO BE SALVAGED SHALL BE DELIVERED TO THE OWNER IN AN AGREED UPON LOCATION UNDAMAGED AND PROTECTED IN AN
- APPROPRIATE MANNER. 7. PROTECT EXISTING WORK INDICATED TO REMAIN. CONTRACTOR WILL BE RESPONSIBLE FOR REPLACEMENT OF DAMAGED WORK SCHEDULED TO REMAIN. 8. COMPLY WITH NFPA 241, STANDARD FOR SAFEGUARDING CONSTRUCTION, ALTERATION AND DEMOLITION OPERATIONS, CURRENT EDITION, AND WITH ALL OTHER APPLICABLE LOCAL CODES AND ORDINANCES REGARDING DEMOLITION
- ACTIVITIES. 9. INSTALL DUST BARRIERS, CONSTRUCTION FENCING, BARRICADES, ETC. TO KEEP NON-CONSTRUCTION PERSONNEL PROTECTED FROM CONSTRUCTION ACTIVITIES. WHEN APPROPRIATE, TAKE MEASURES TO KEEP DUSTS FROM MIGRATING OUT OF THE IMMEDIATE CONSTRUCTION AREA. CONTRACTOR IS RESPONSIBLE FOR LOCATING EXISTING UTILITY LINES. IN THE EVENT OF A CONFLICT WITH DEMOLITION WORK, NOTIFY ARCHITECT IMMEDIATELY.
- 10. CONTRACTOR IS RESPONSIBLE FOR LOCATING EXISTING UTILITY LINES. IN THE EVENT OF A CONFLICT WITH DEMOLITION WORK, NOTIFY ARCHITECT IMMEDIATELY. 11. CONTRACTOR TO CONFIRM EXTENT OF PARKING PERIMETER WALL BELOW EXISTING PLAZA. POST-TENSIONED CONCRETE DRIVE MUST BE SCANNED PRIOR TO EXPLORATORY DEMOLITION.
- 12. ITEMS INDICATED TO REMAIN SHALL BE PROTECTED IN APPROPRIATE MANNER. 13. REFER TO SHEET A502 REGARDING SLIDING GLASS ENTRY TO REMAIN.
- 14. EXTERIOR FINISH MATERIALS ON EXISTING COLUMNS TO REMAIN ARE TO BE REMOVED. 15. COORDINATE REMOVAL OF ALL UNUSED CONDUIT AND JUNCTION BOXES AT EXTERIOR.
- 16. CONTACT ARCHITECT IF THERE IS A QUESTION REGARDING MATERIALS TO BE REMOVED.

EXISTING TO REMAIN _ - - - - - -

EXISTING TO BE DEMOLISHED _ _ _ _ _ _

EXISTING CONDITIONS

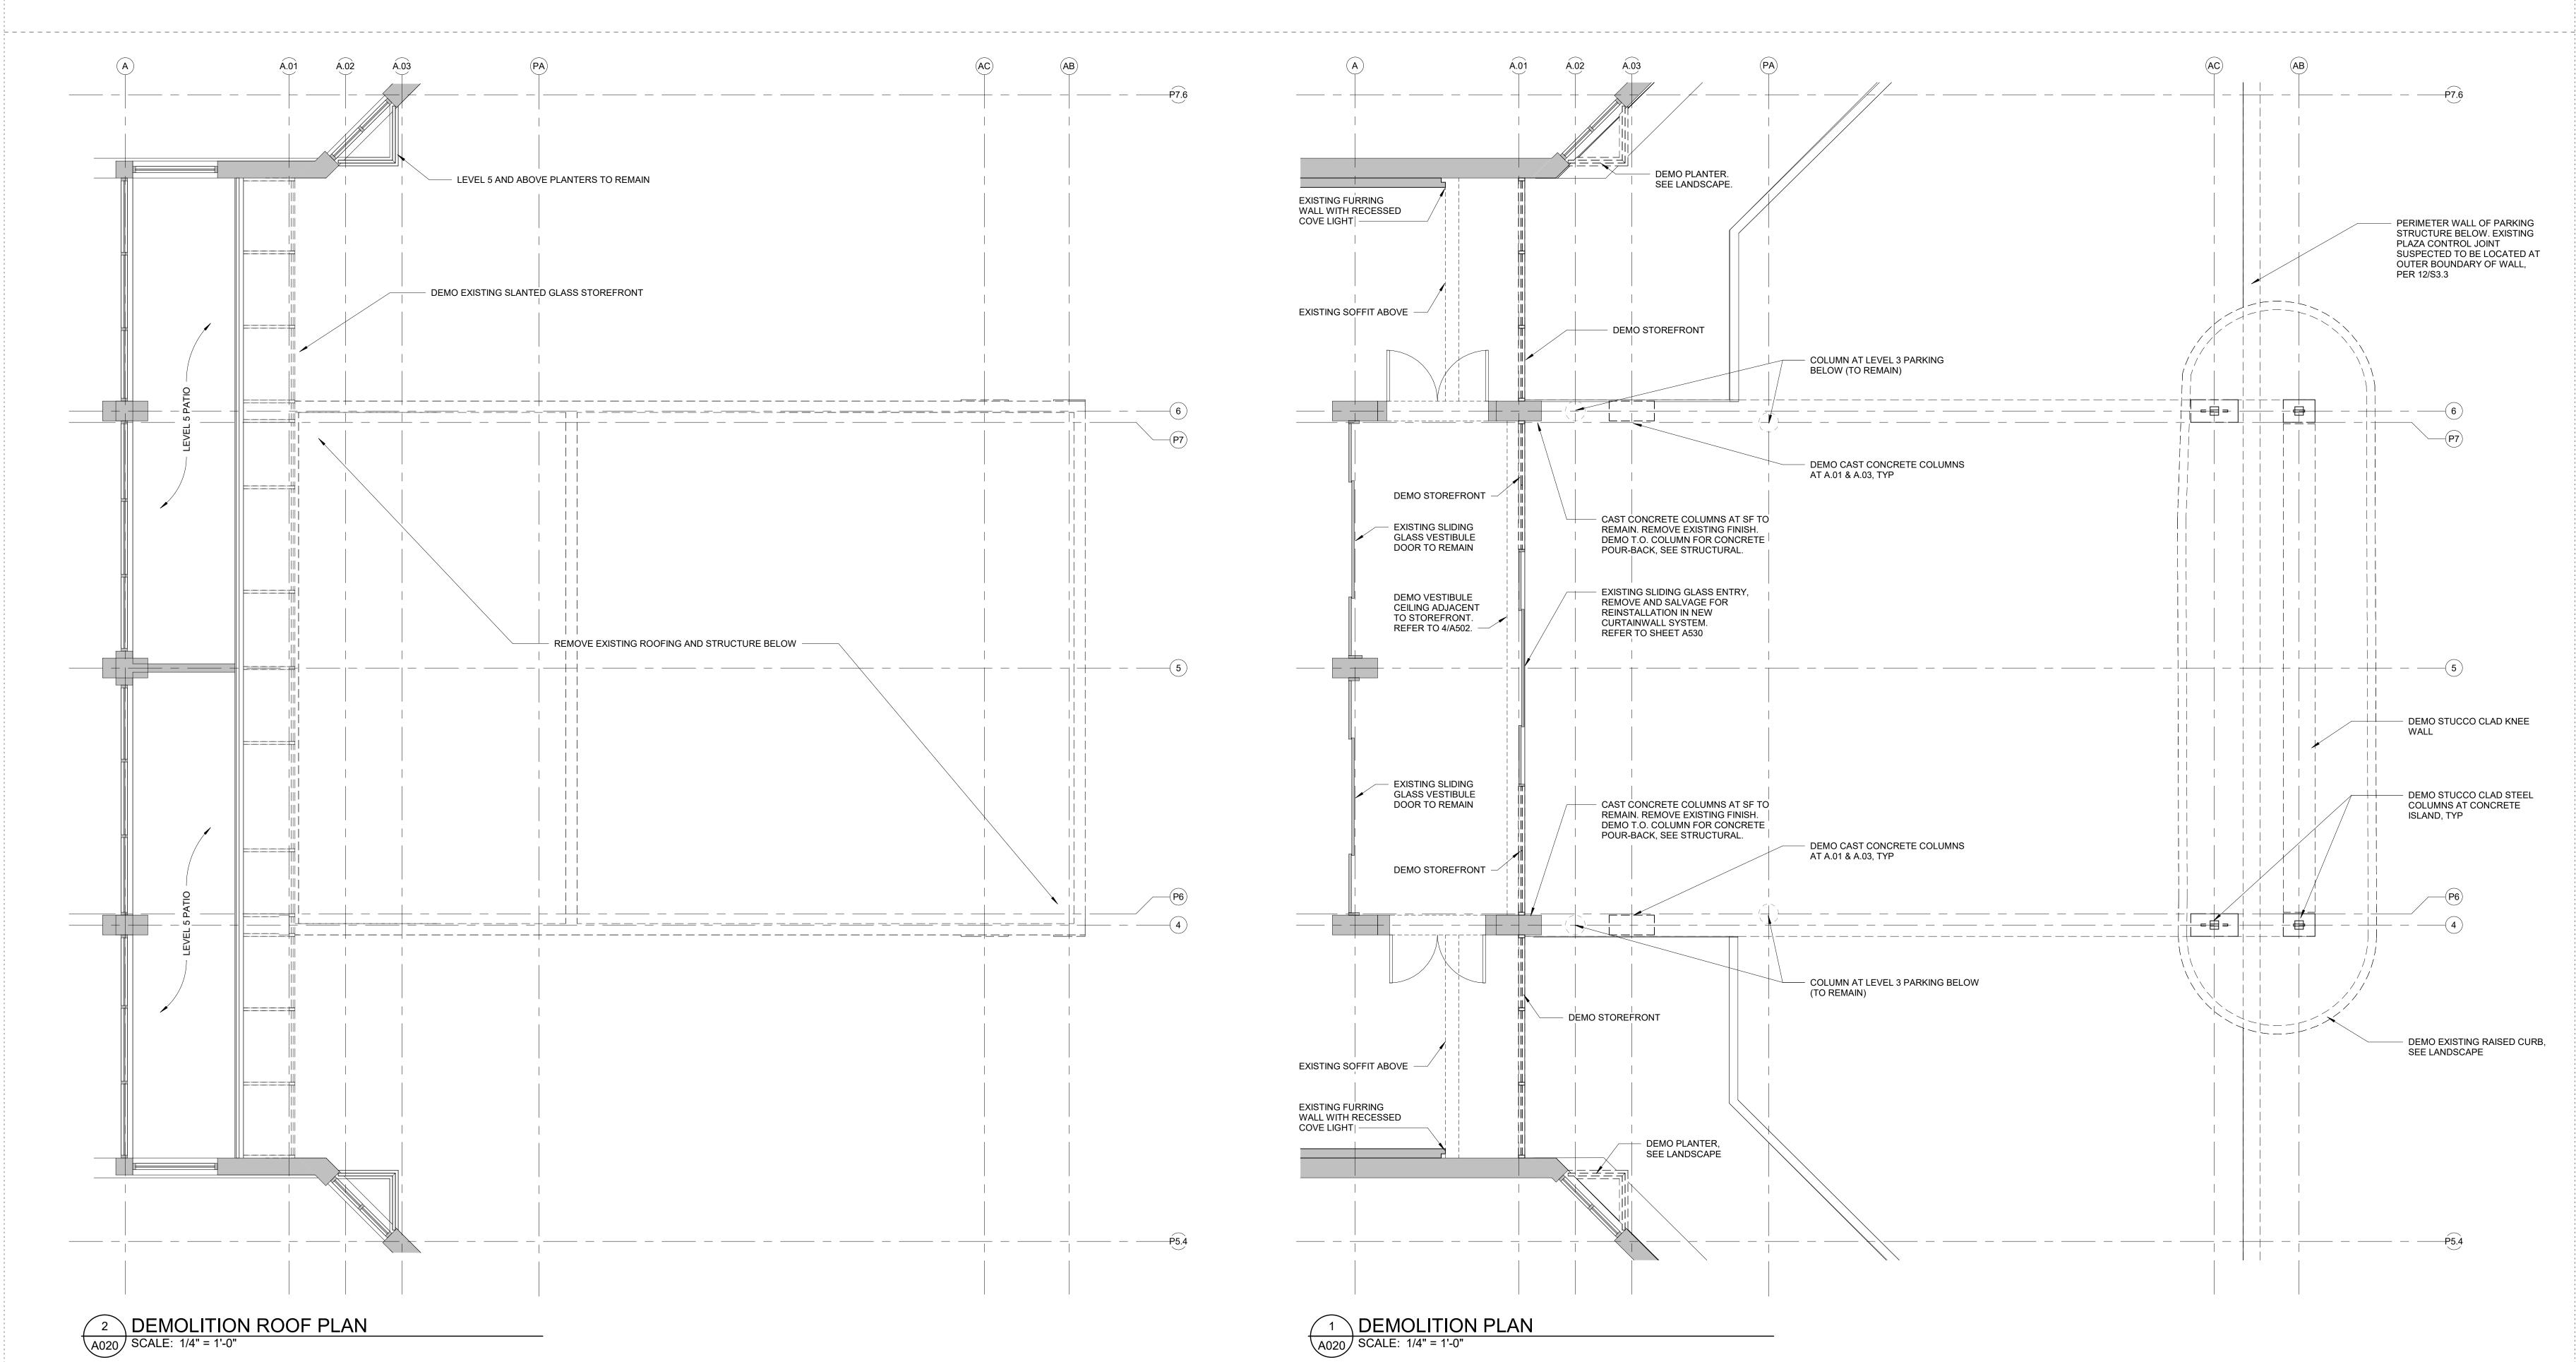

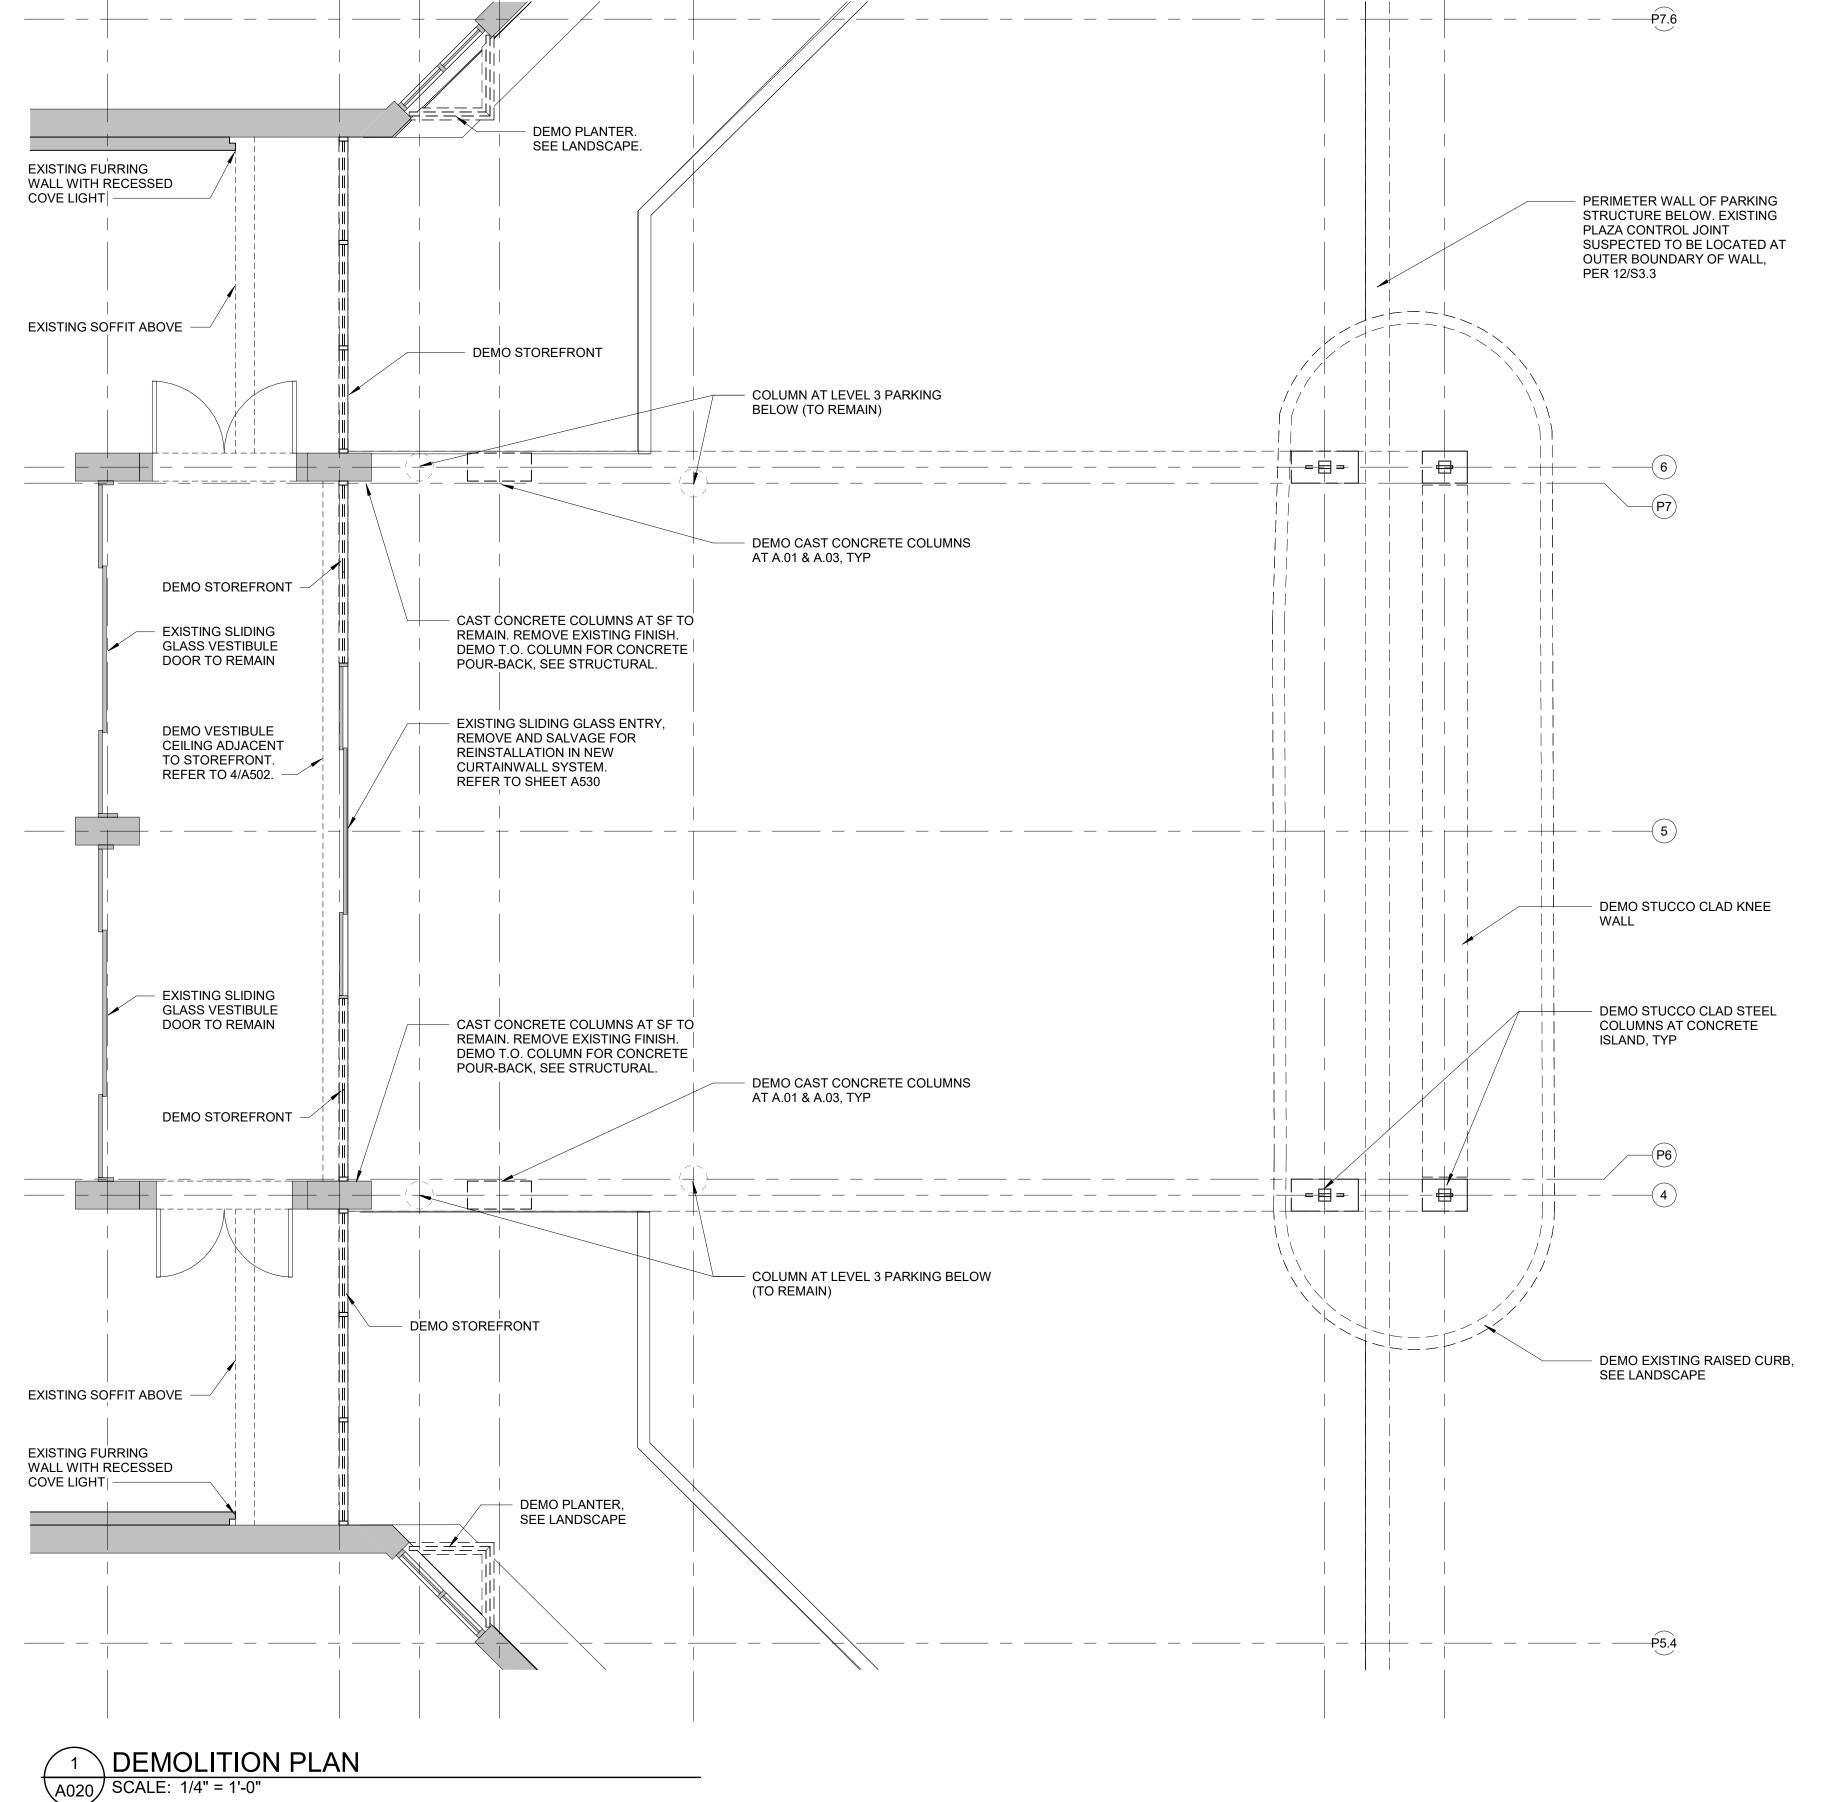

PROJECT NO: PROJECT TITLE:

ARCHITECTS

83 Poplar Street NW


ATLANTA, GA 30303 404.892.2443 voice

mail@smithdalia.com

CONSULTANT:


Construction Documents OCTOBER 31, 2023

1 312/15/23 ADDENDUM 1

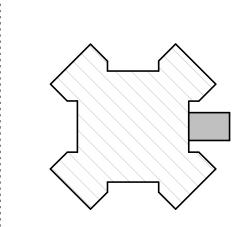




DEMOLITION PLANS

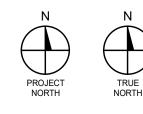

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A020

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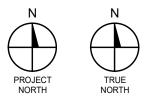
404.892.2443 voice mail@smithdalia.com

PROJECT NO: Park Place PROJECT TITLE:
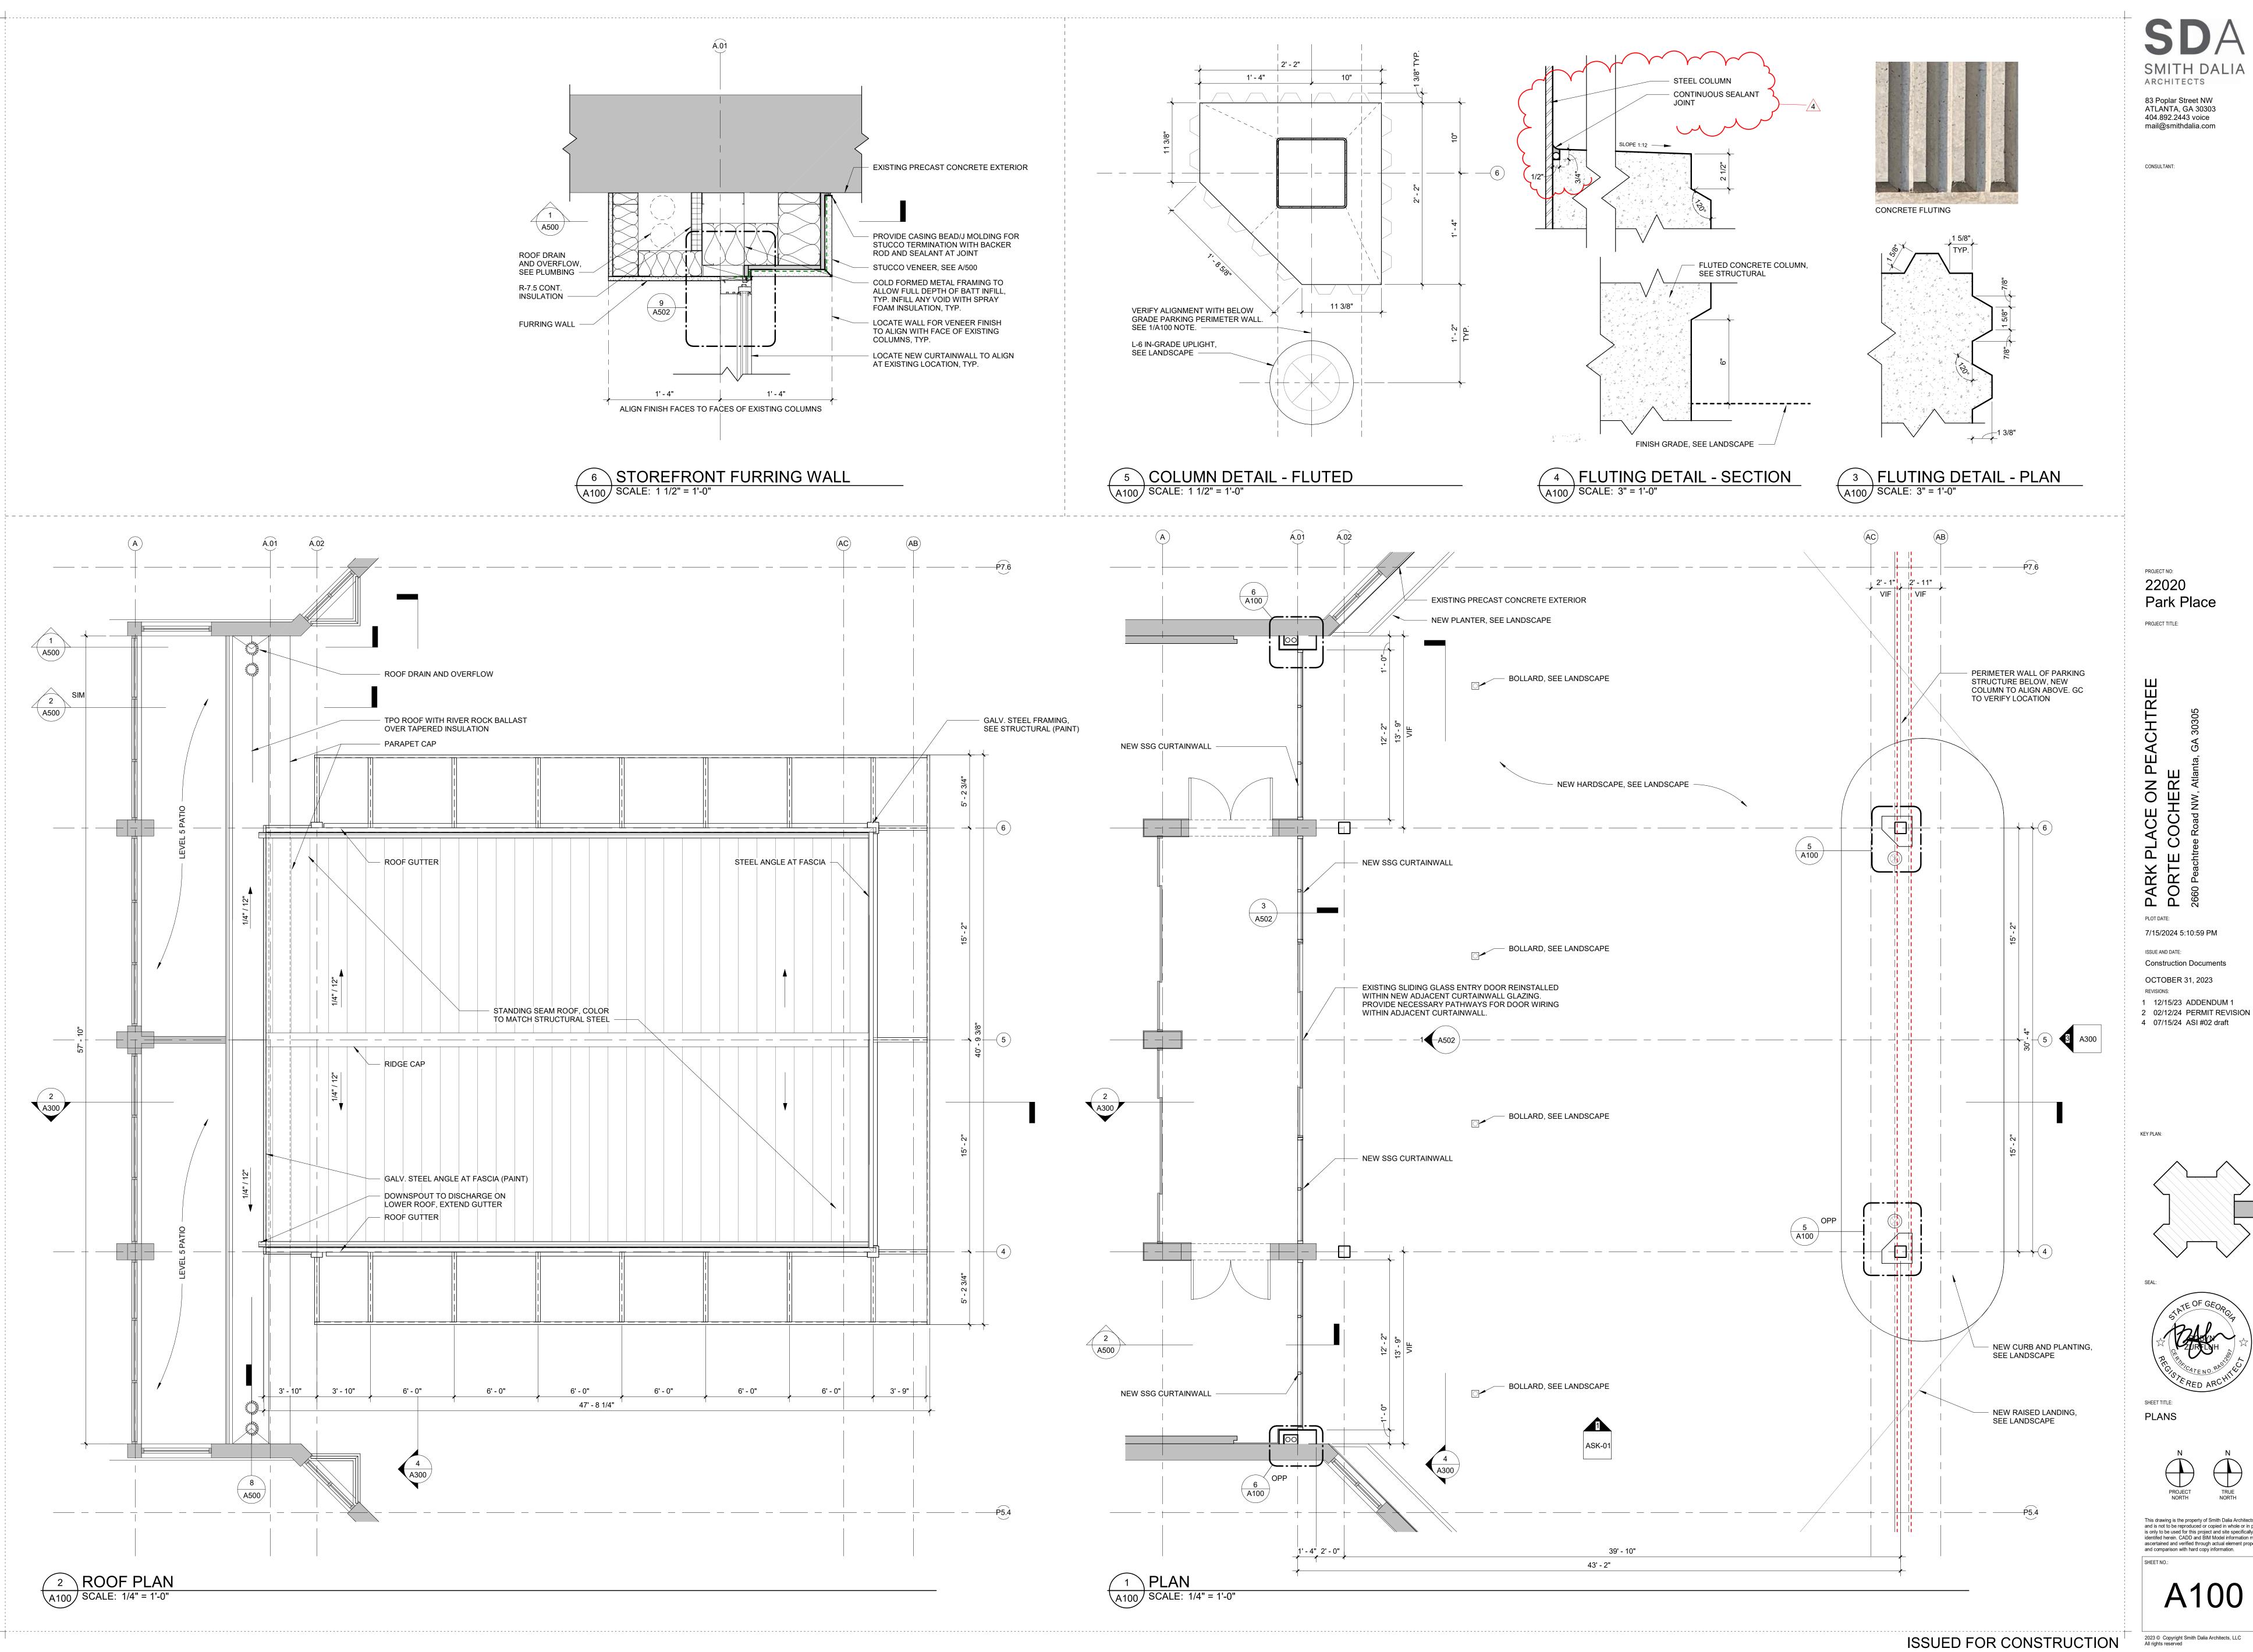
> PLOT DATE: 7/15/2024 5:10:59 PM ISSUE AND DATE: Construction Documents OCTOBER 31, 2023 REVISIONS: 1 12/15/23 ADDENDUM 1





SHEET TITLE:



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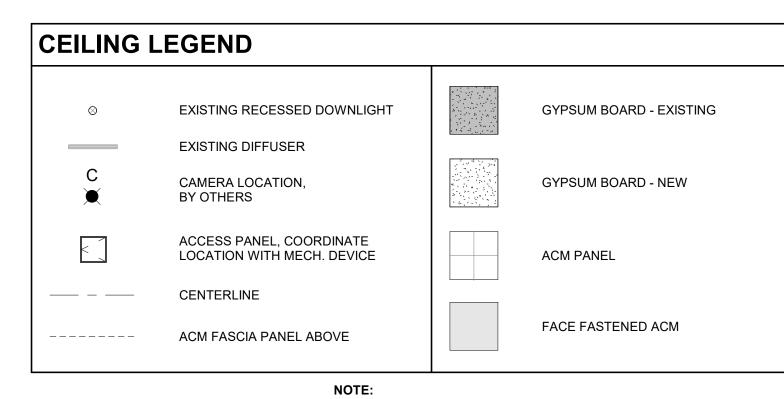
A100



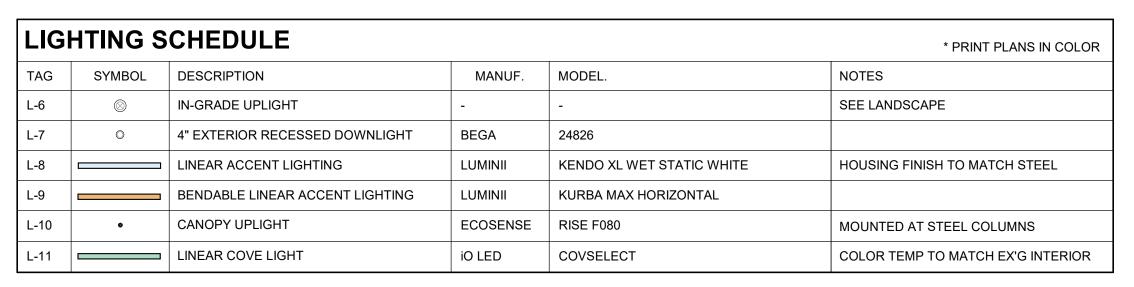


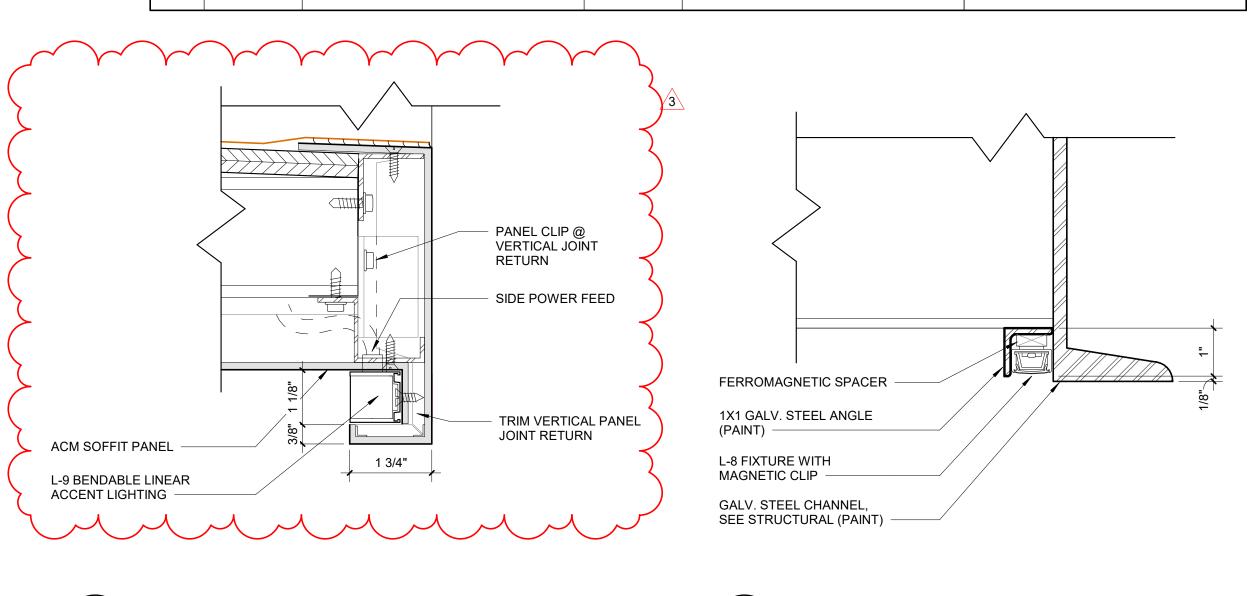3 SOFFIT EDGE LIGHT DETAIL
A200 SCALE: 6" = 1'-0"





NOTE:
1. REFER TO LIGHTING SCHEDULE FOR NEW FIXTURE LEGEND.
2. PROVIDE AESS AT ALL PERMANENTLY EXPOSED STRUCTURAL STEEL.

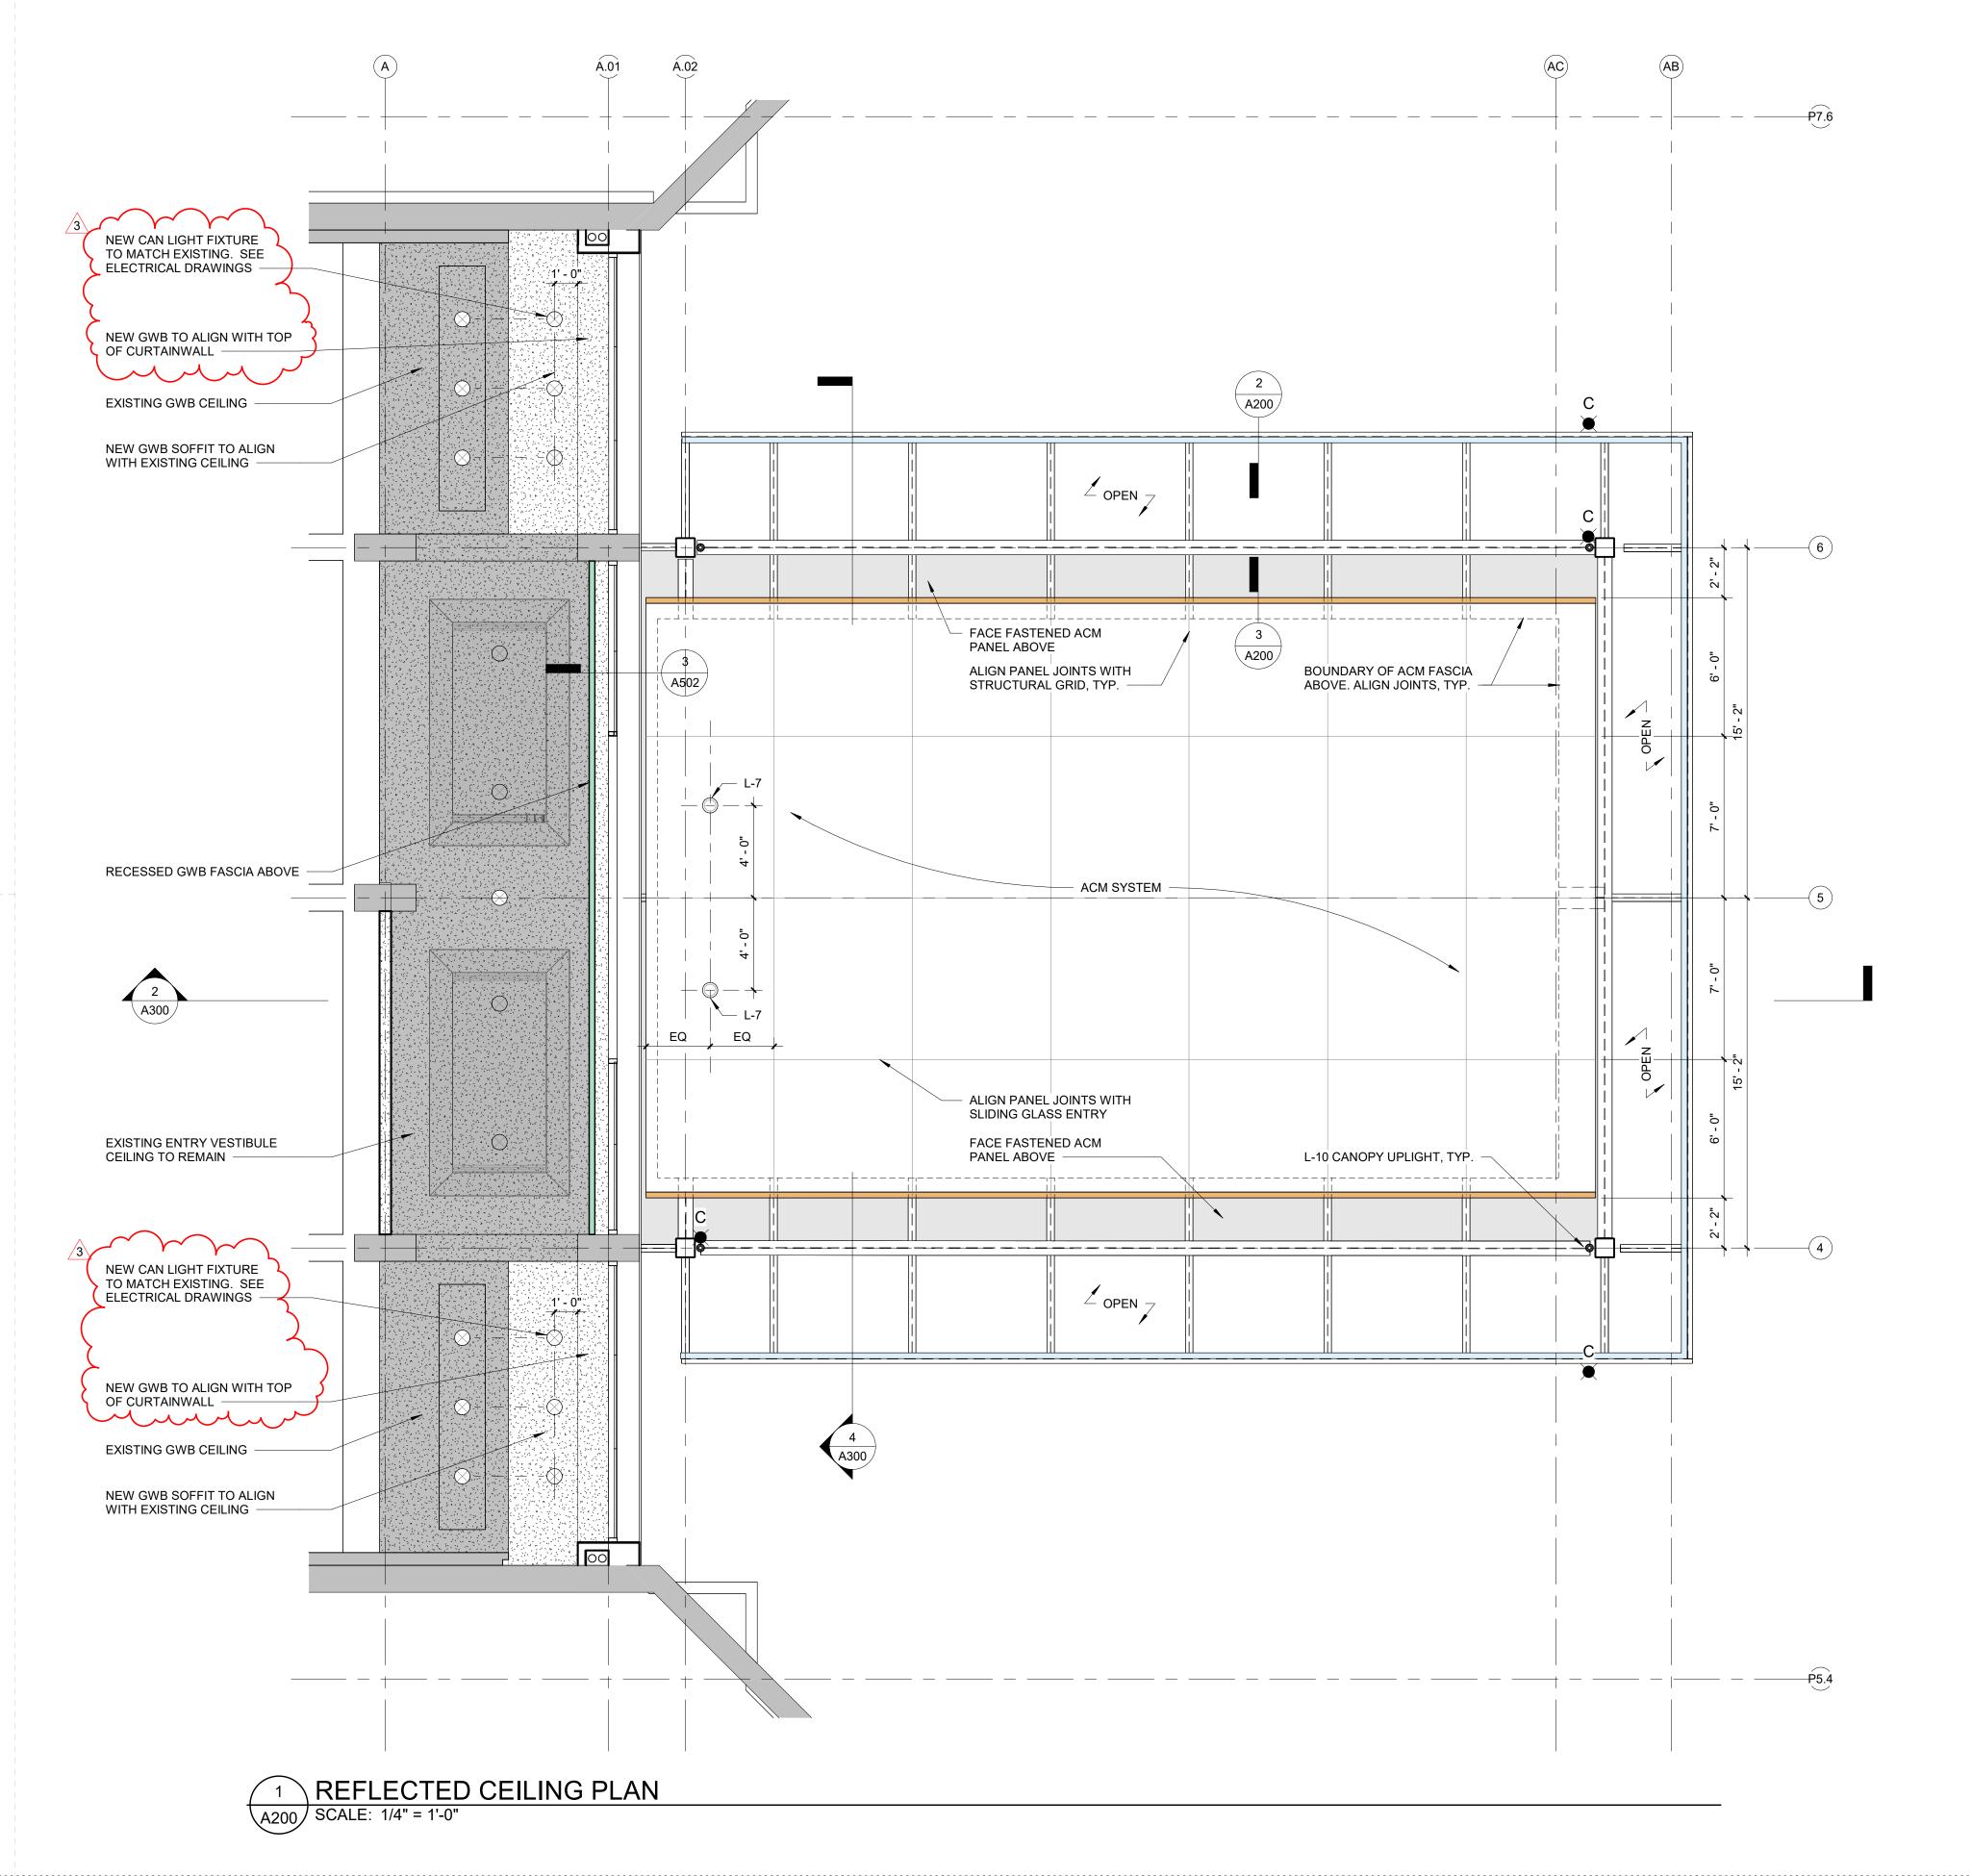

PROJECT NO:

22020

Park Place

PROJECT TITLE:

ARCHITECTS

83 Poplar Street NW

ATLANTA, GA 30303 404.892.2443 voice

mail@smithdalia.com

CONSULTANT:

PARK PLACE ON PEACHTREE
PORTE COCHERE
2660 Peachtree Road NW, Atlanta, GA 30305

4/22/2024 11:08:11 AM

Construction Documents


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 2 02/12/24 PERMIT REVISION

OCTOBER 31, 2023

3 04/18/24 ASI #01


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REVISIONS:



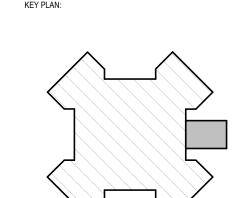


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A200

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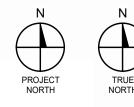
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PROJECT NO:

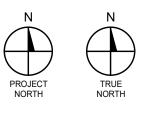PLOT DATE: 4/22/2024 10:53:23 AM




SECTIONS & **ELEVATIONS**

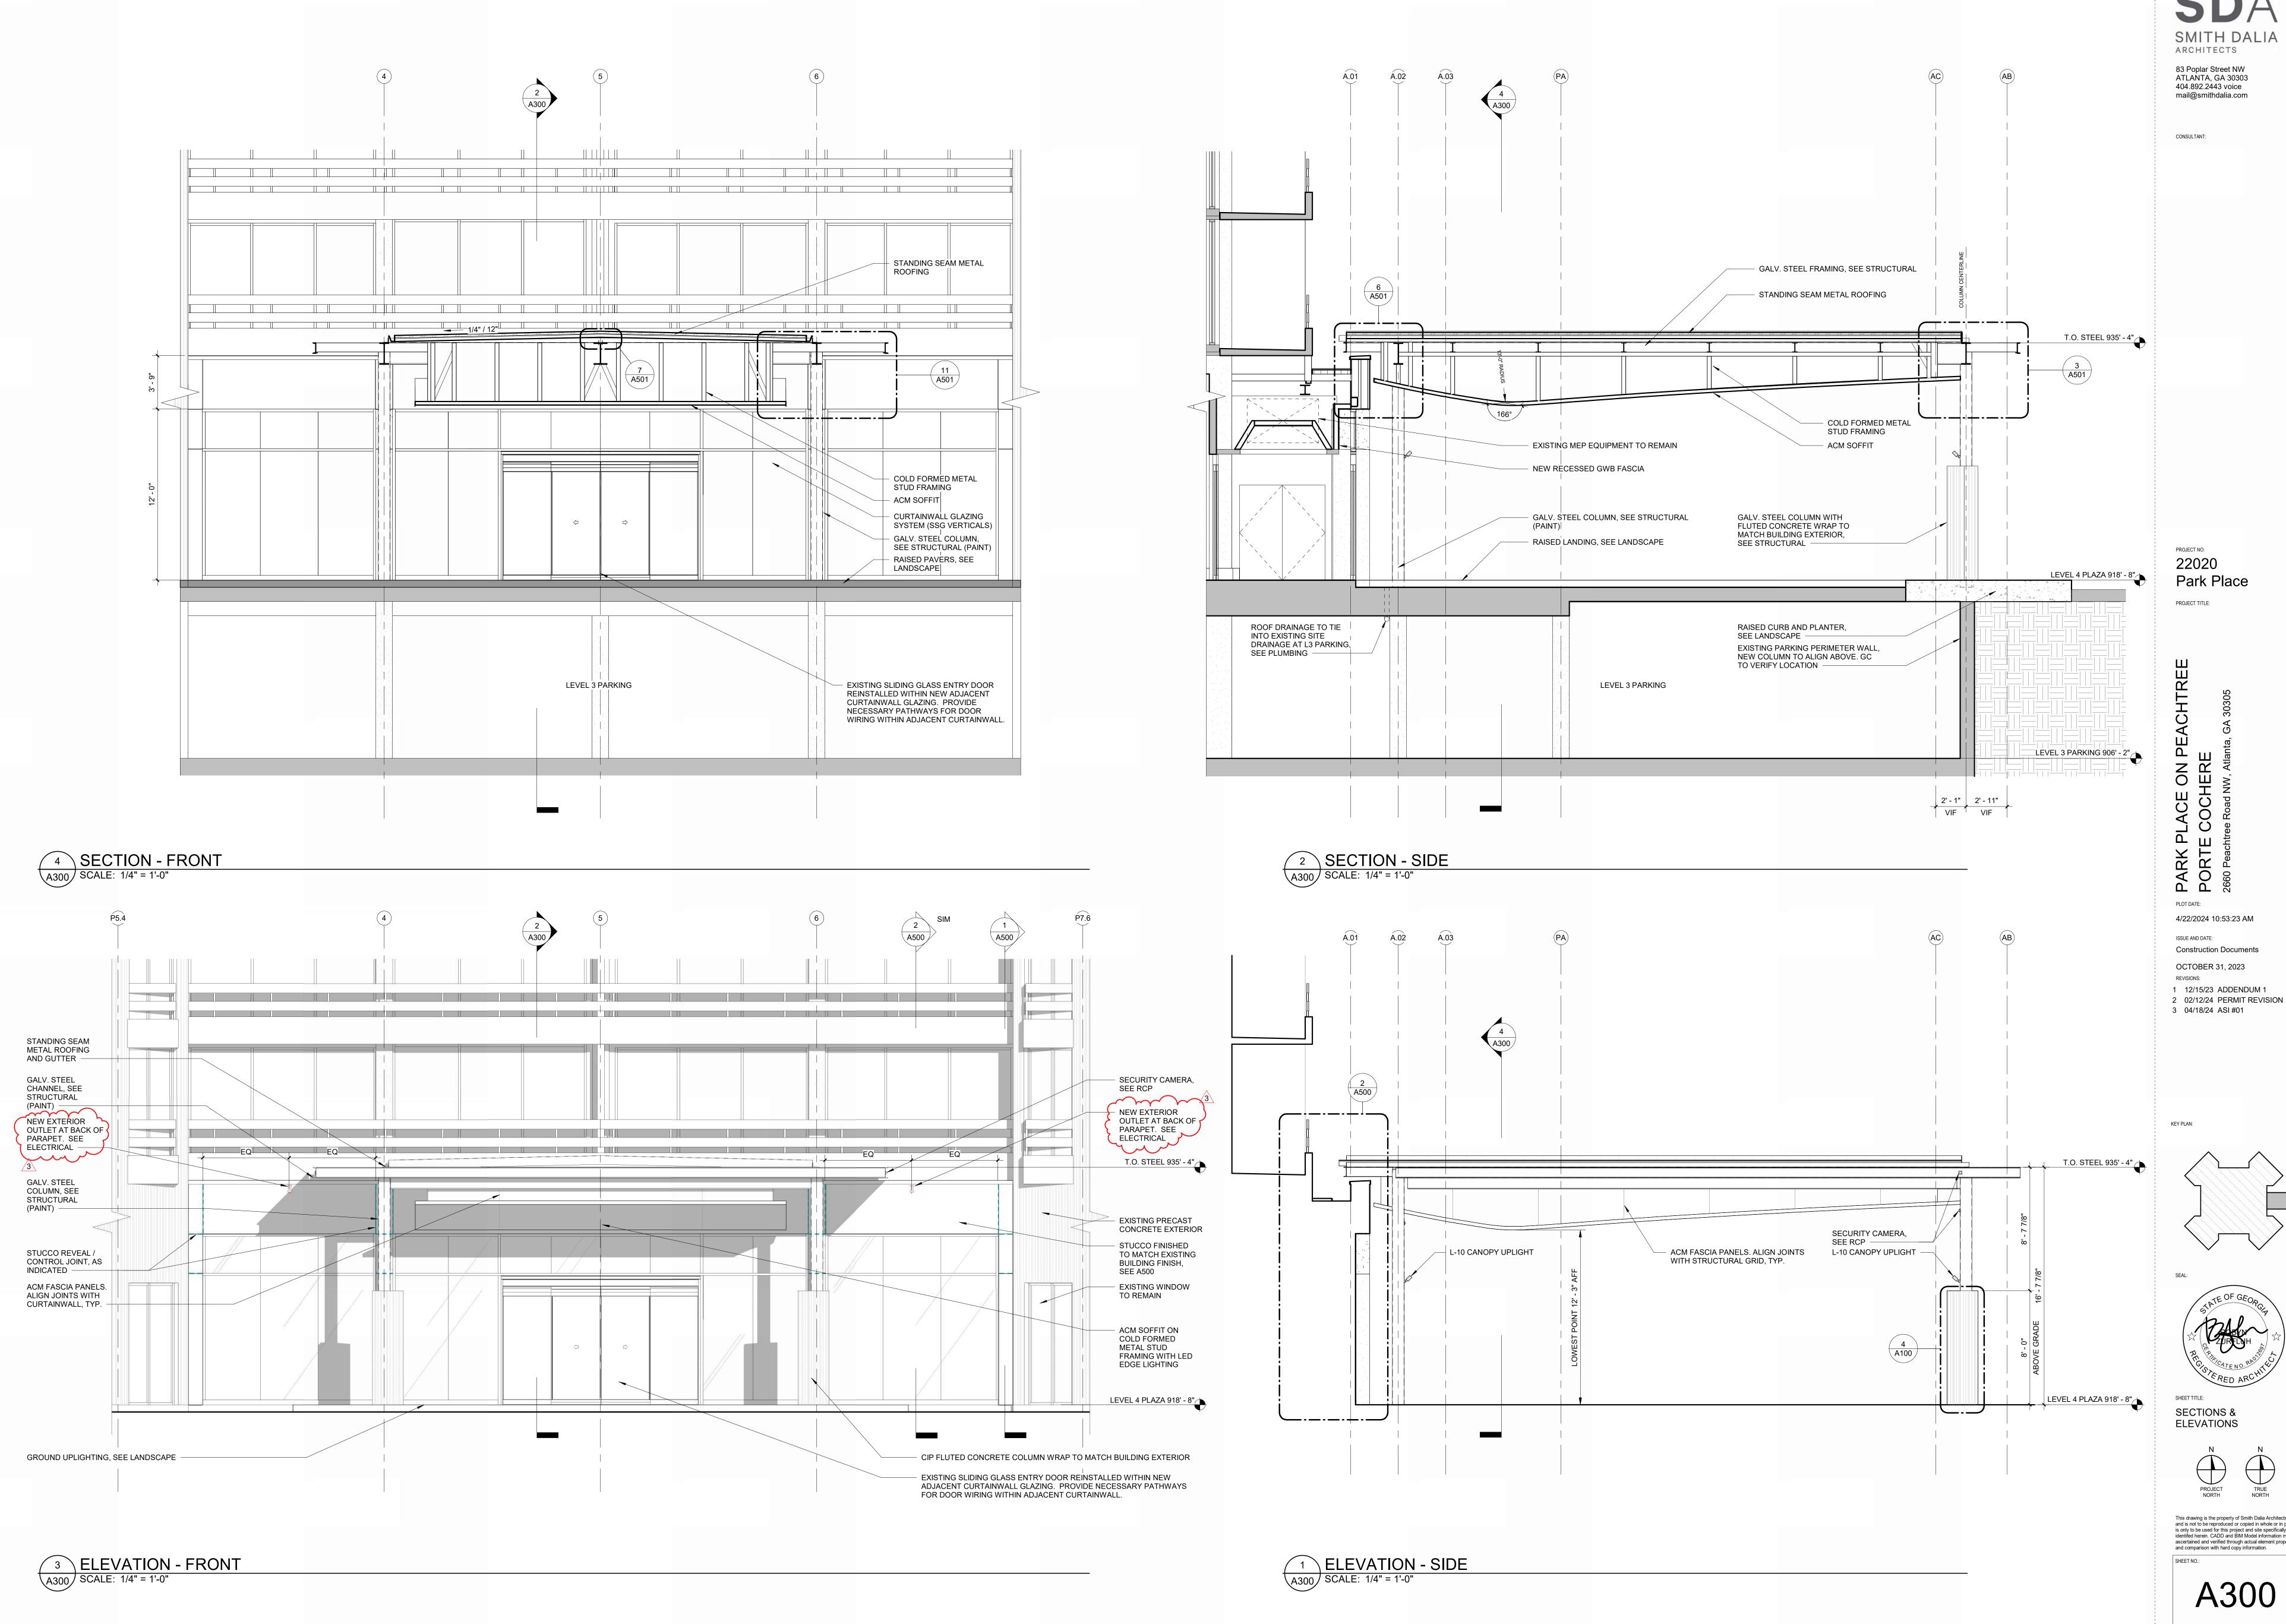


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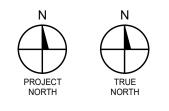


ARCHITECTS 83 Poplar Street NW ATLANTA, GA 30303 404.892.2443 voice mail@smithdalia.com CONSULTANT: PROJECT NO: 22020 Park Place PROJECT TITLE: PLOT DATE: 4/22/2024 10:54:34 AM ISSUE AND DATE: Construction Documents OCTOBER 31, 2023 REVISIONS: 1 12/15/23 ADDENDUM 1 2 02/12/24 PERMIT REVISION 3 04/18/24 ASI #01

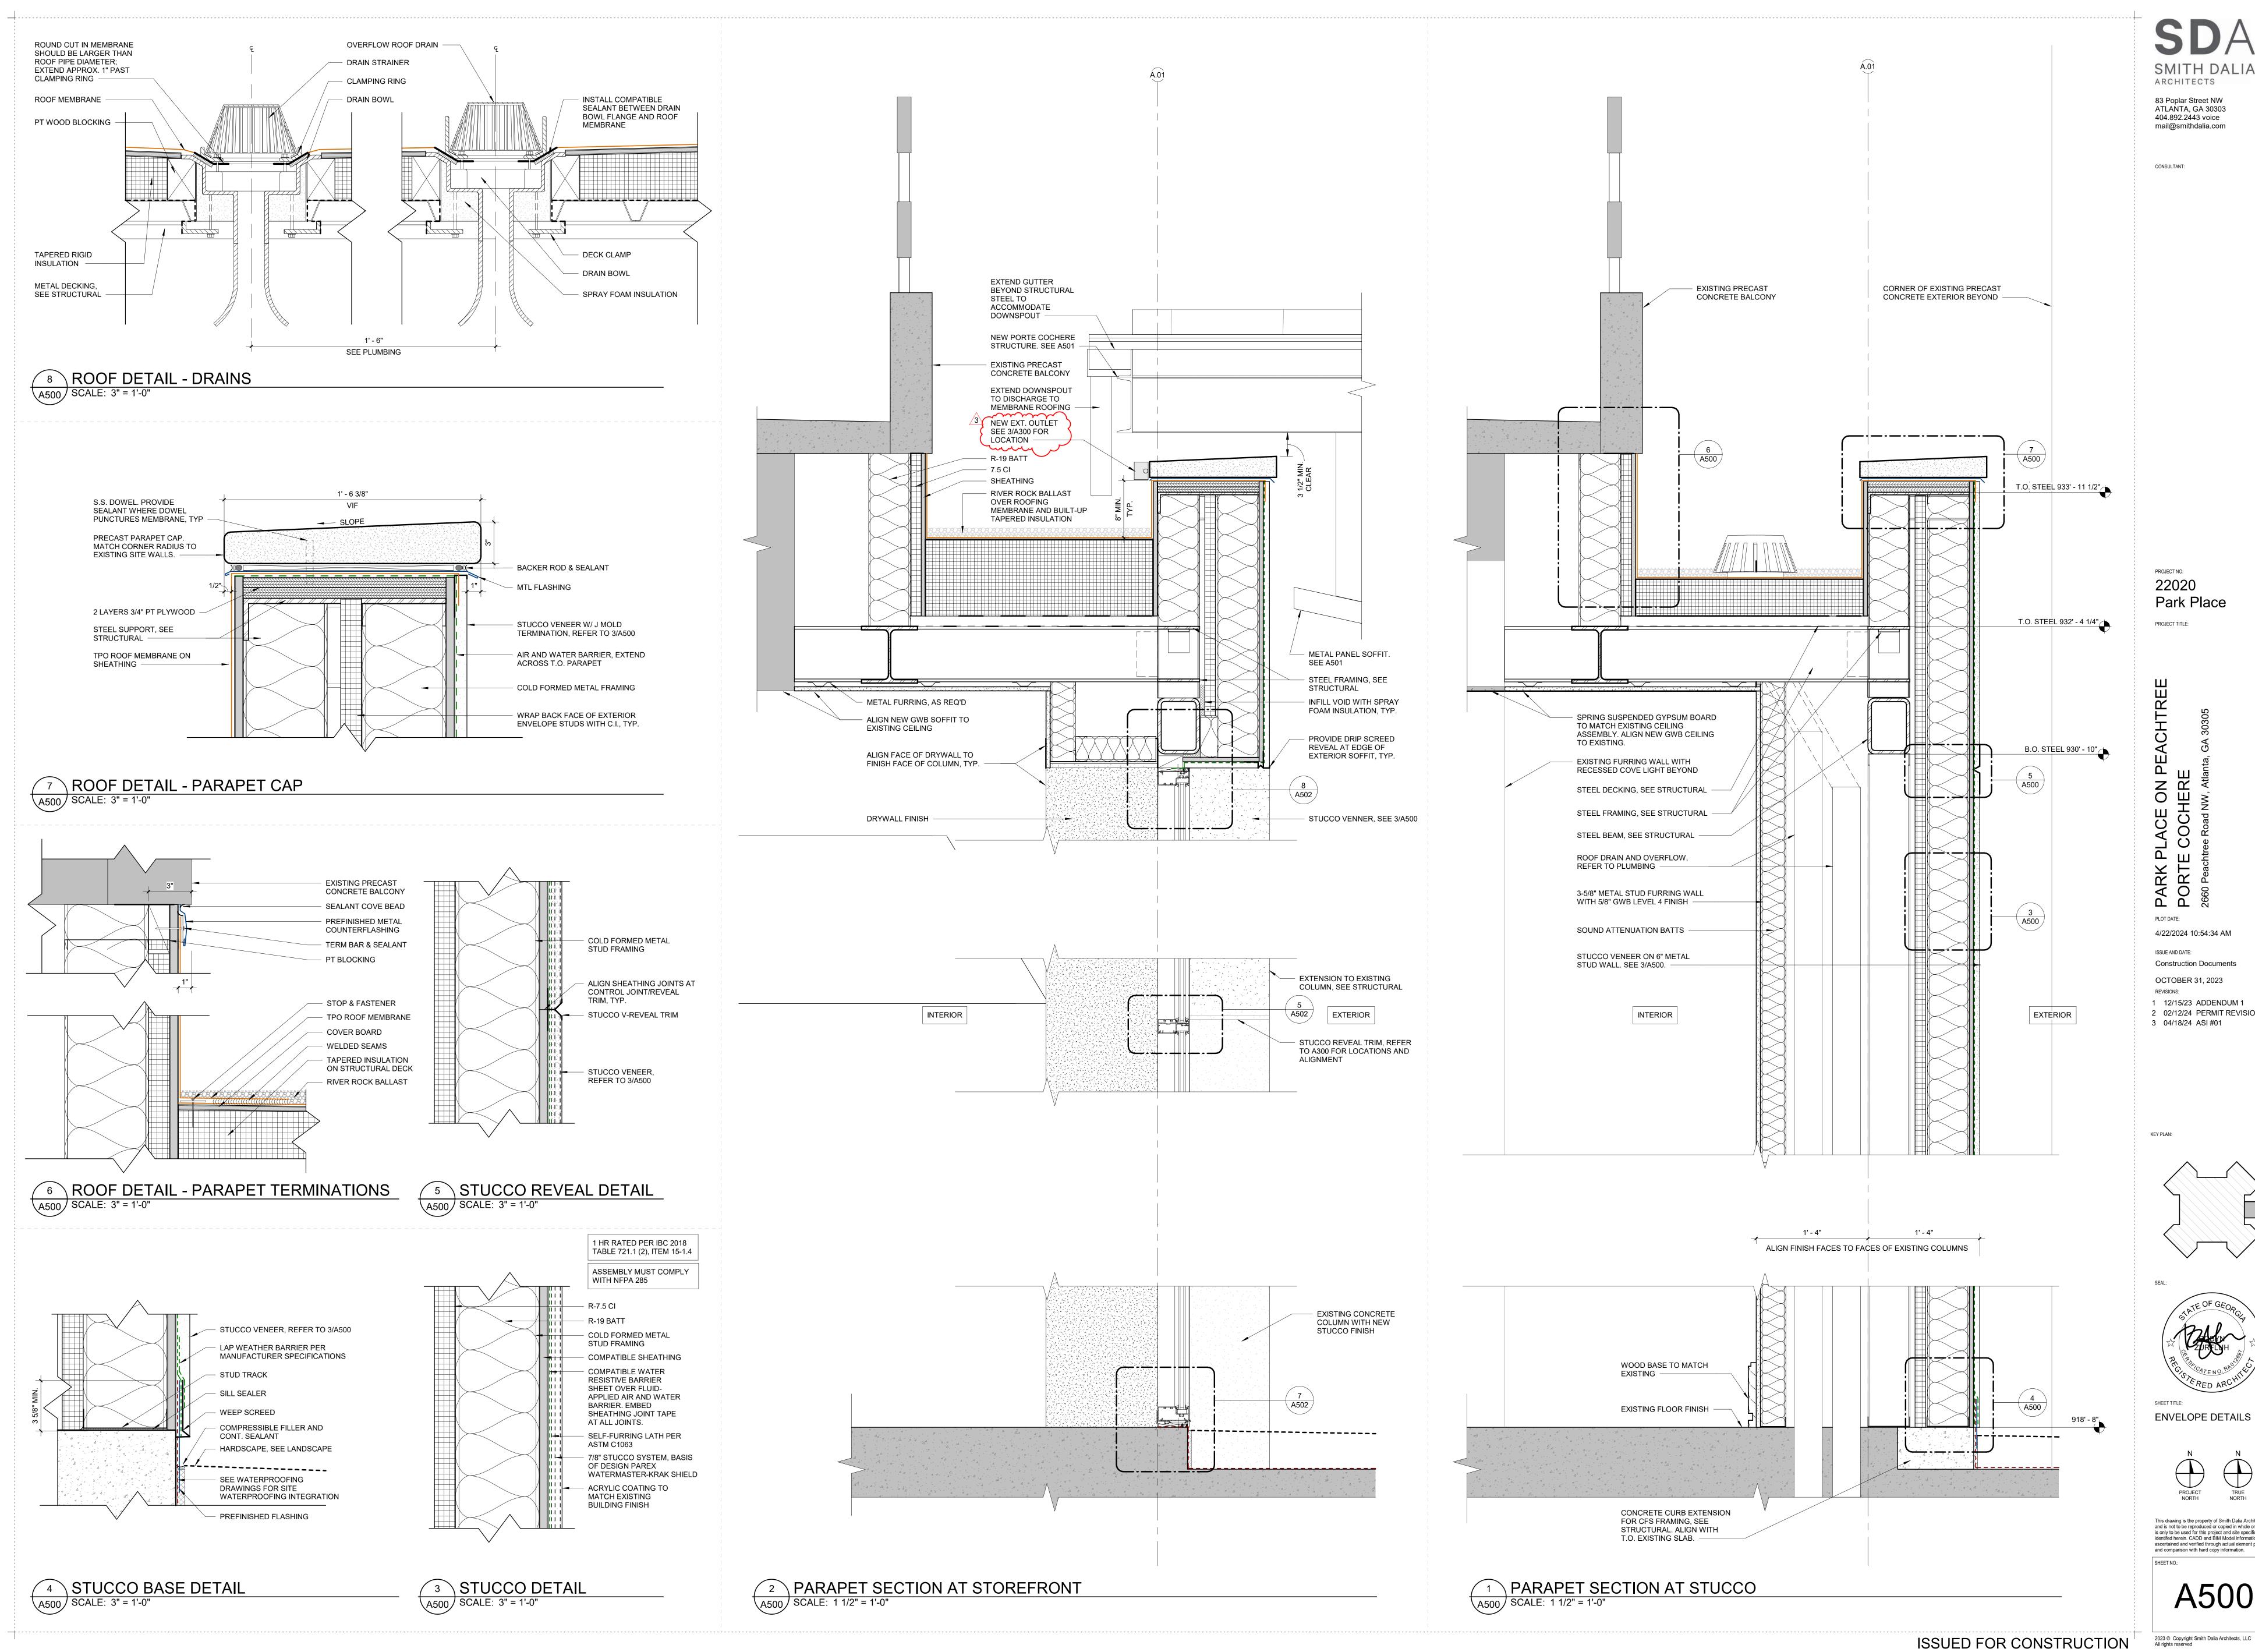

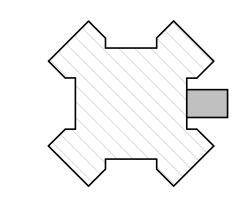



SHEET TITLE: ENVELOPE DETAILS



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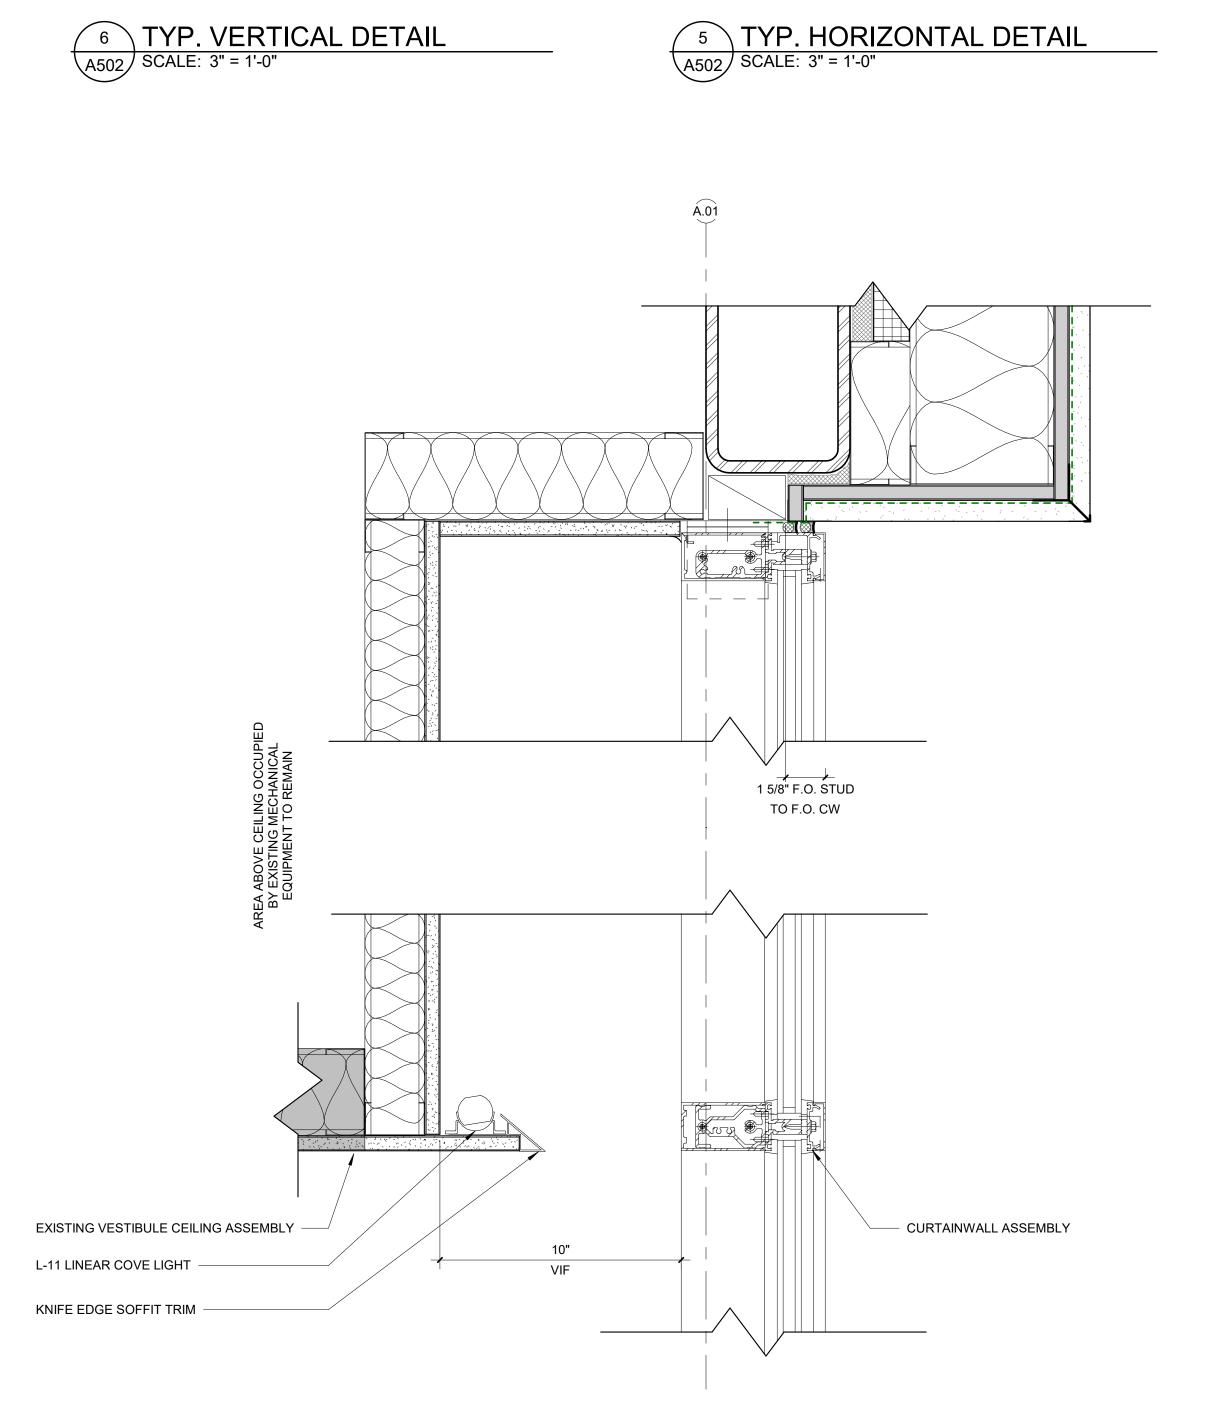
A500




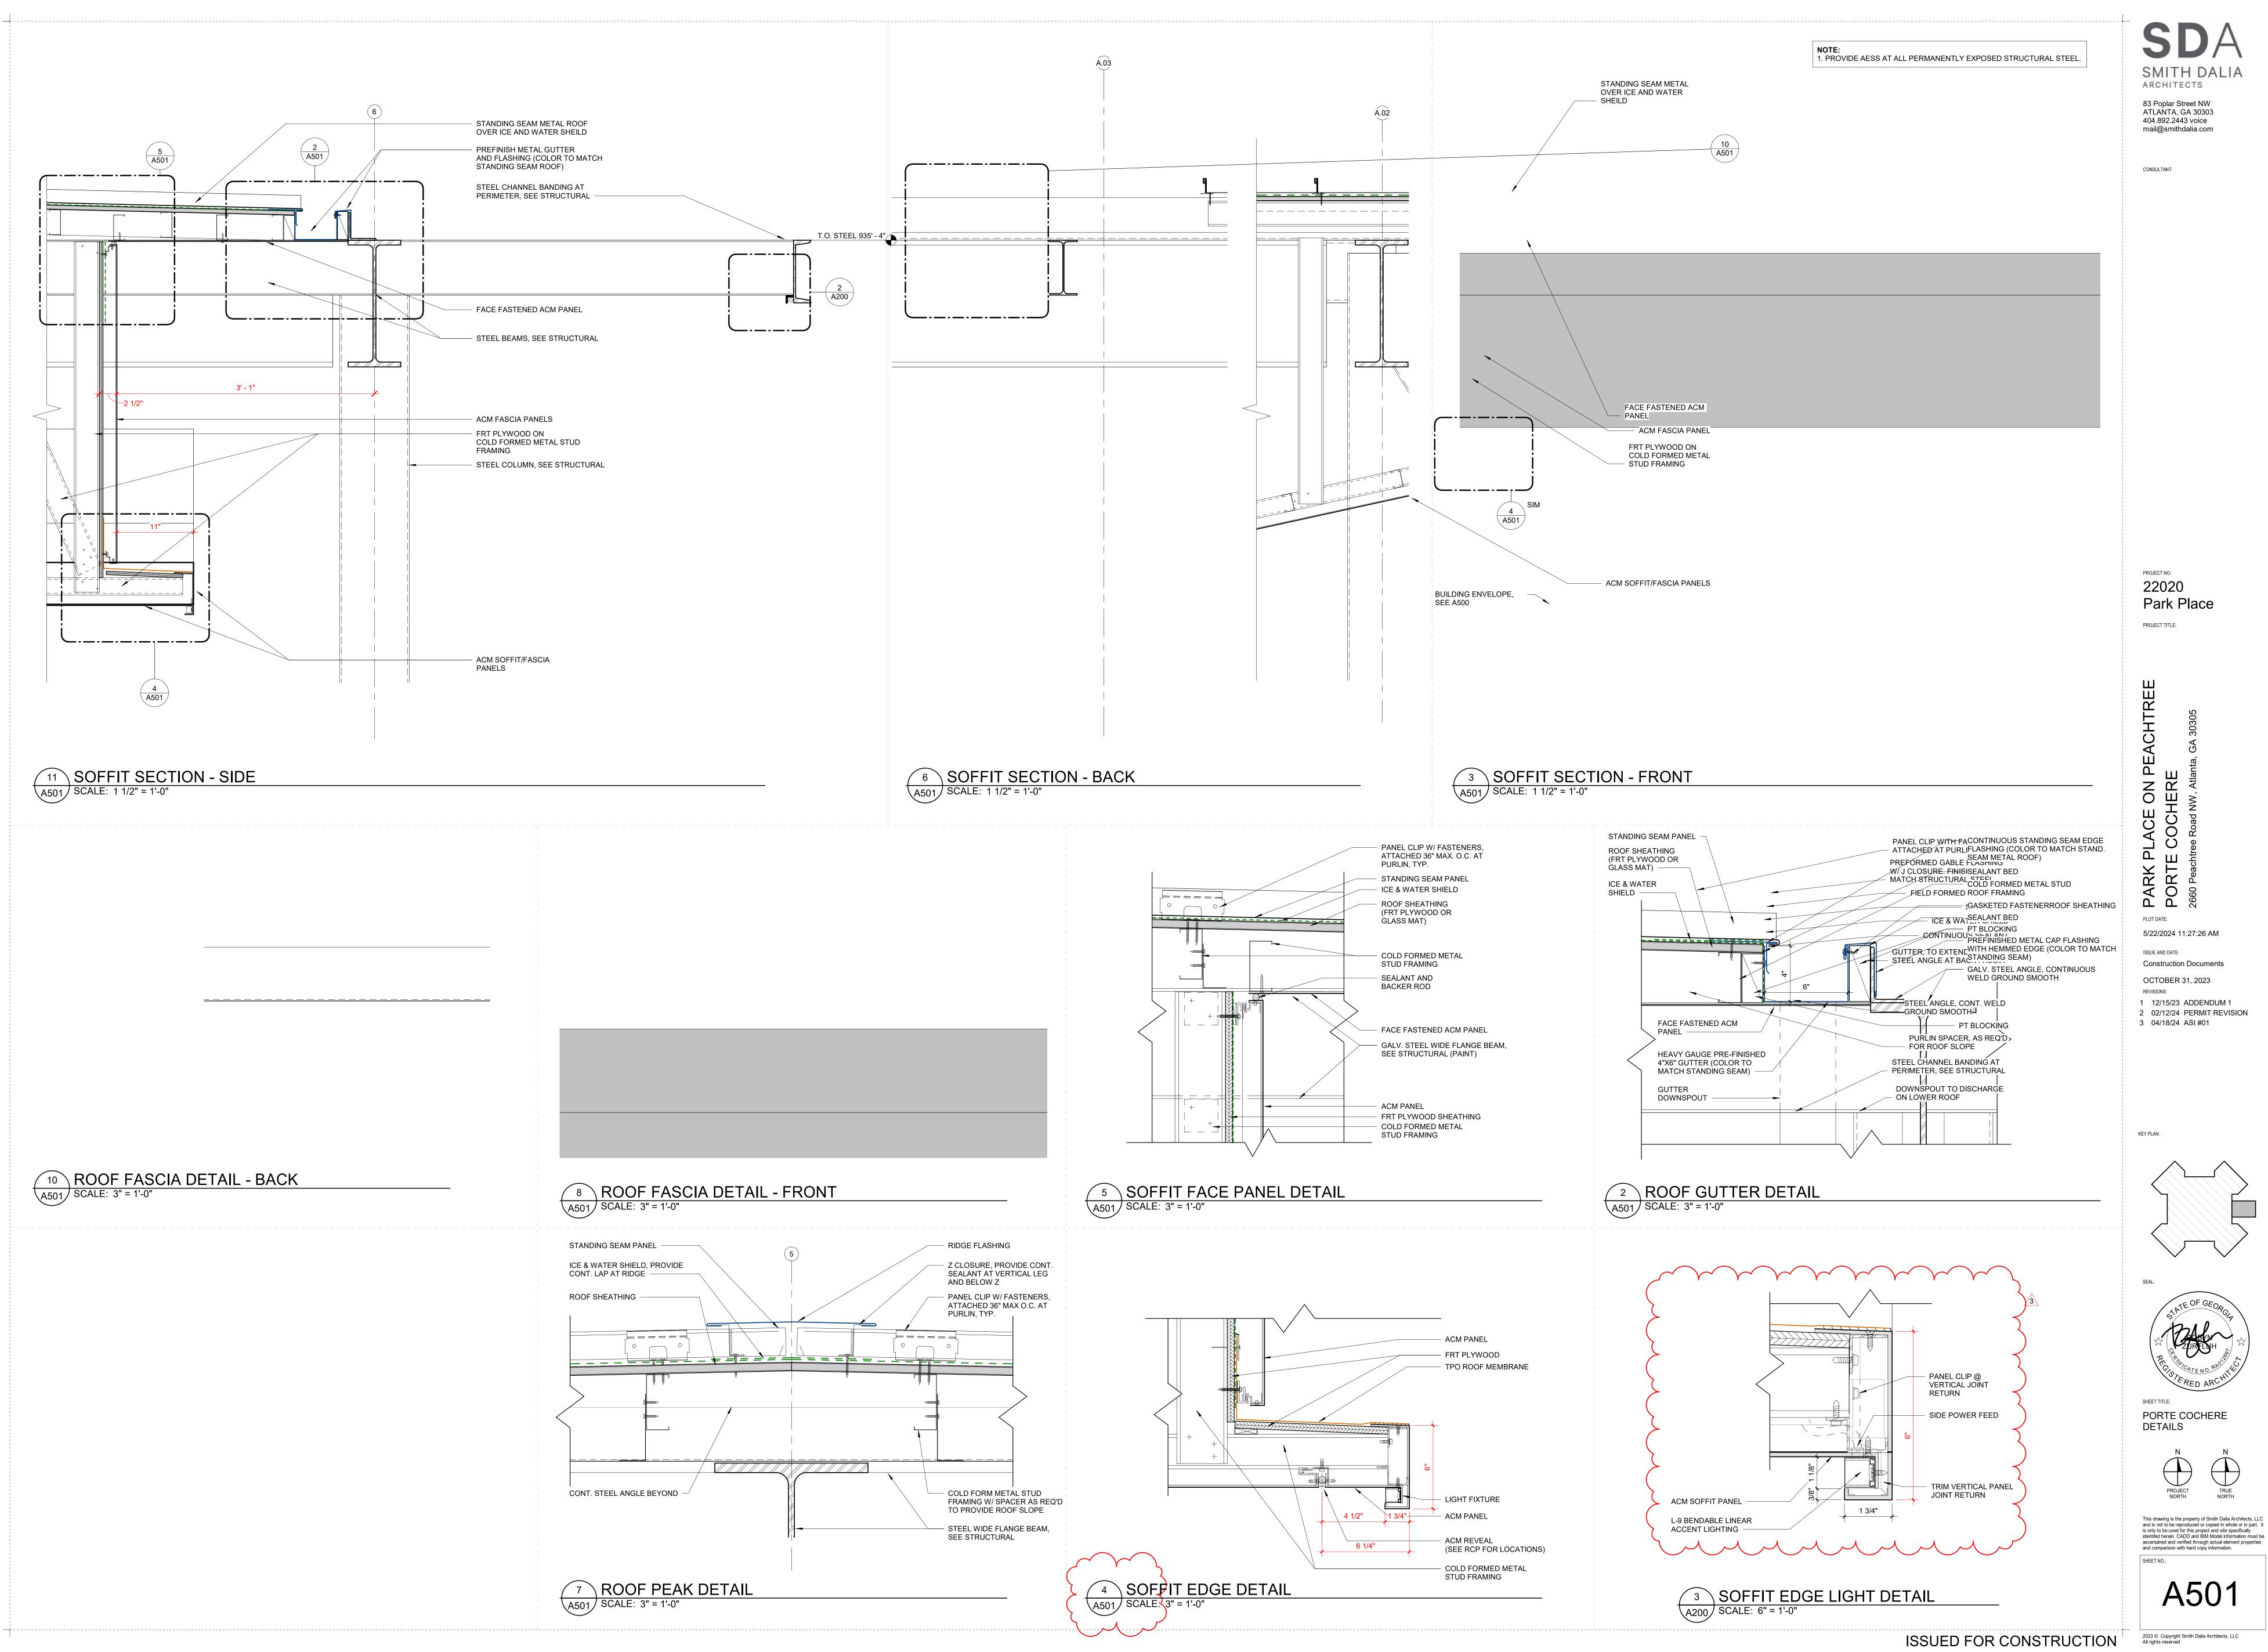


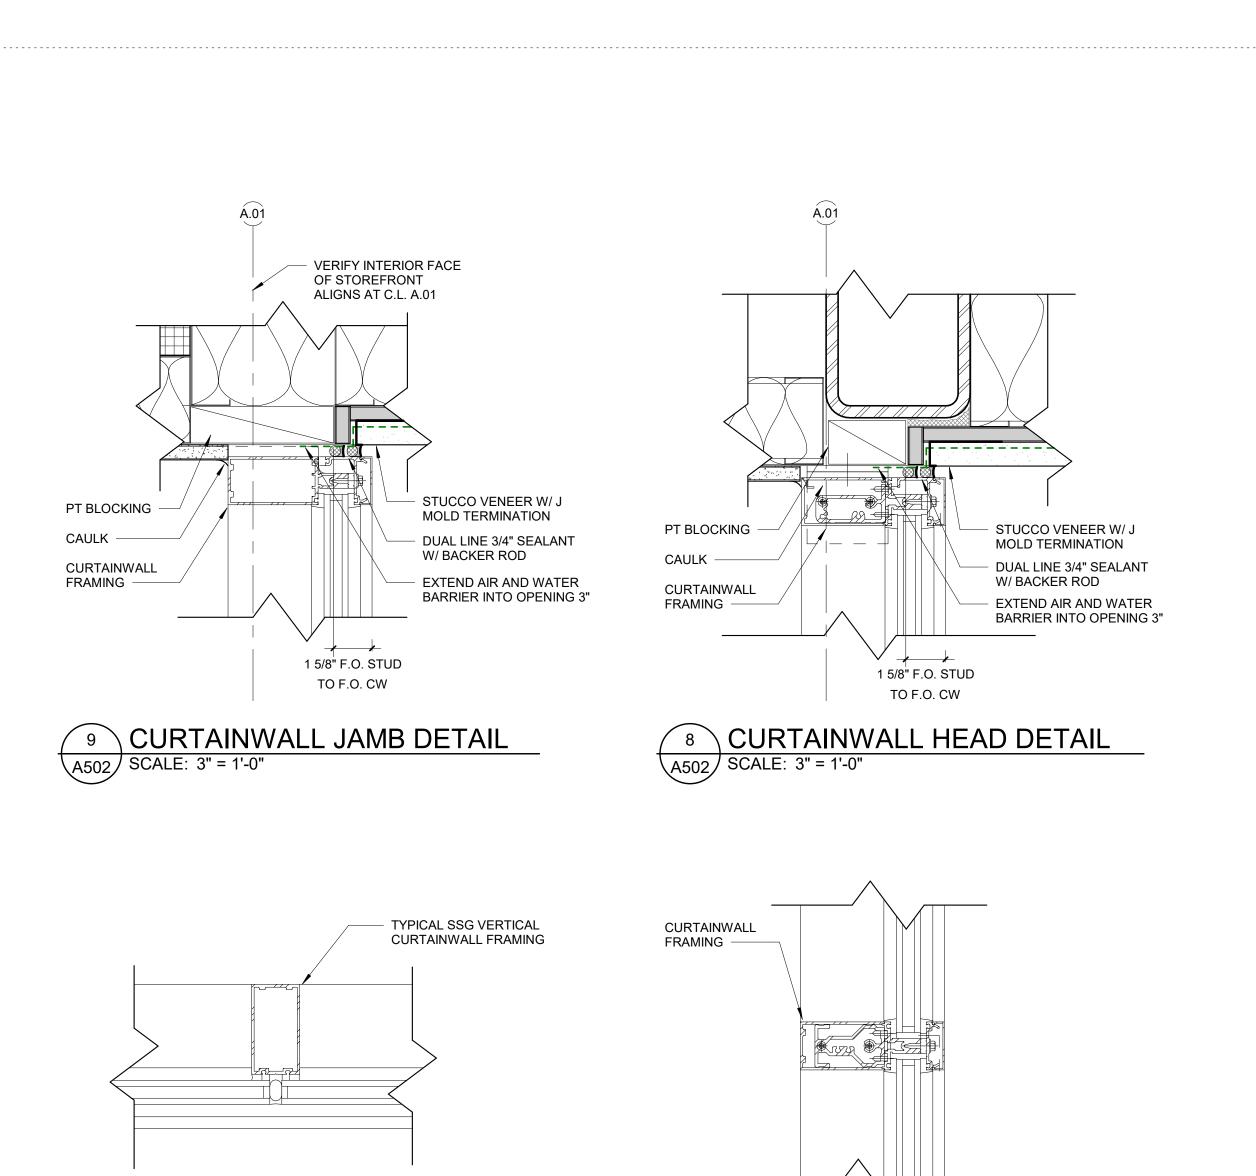
5 TYP. HORIZONTAL DETAIL

A502 SCALE: 3" = 1'-0"




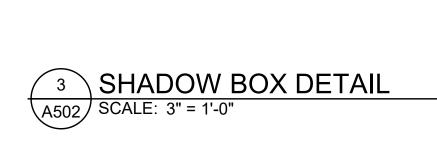

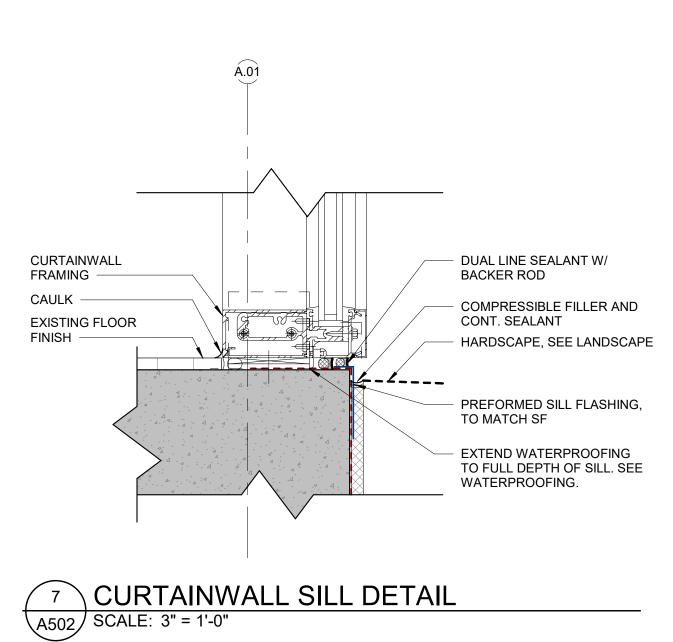


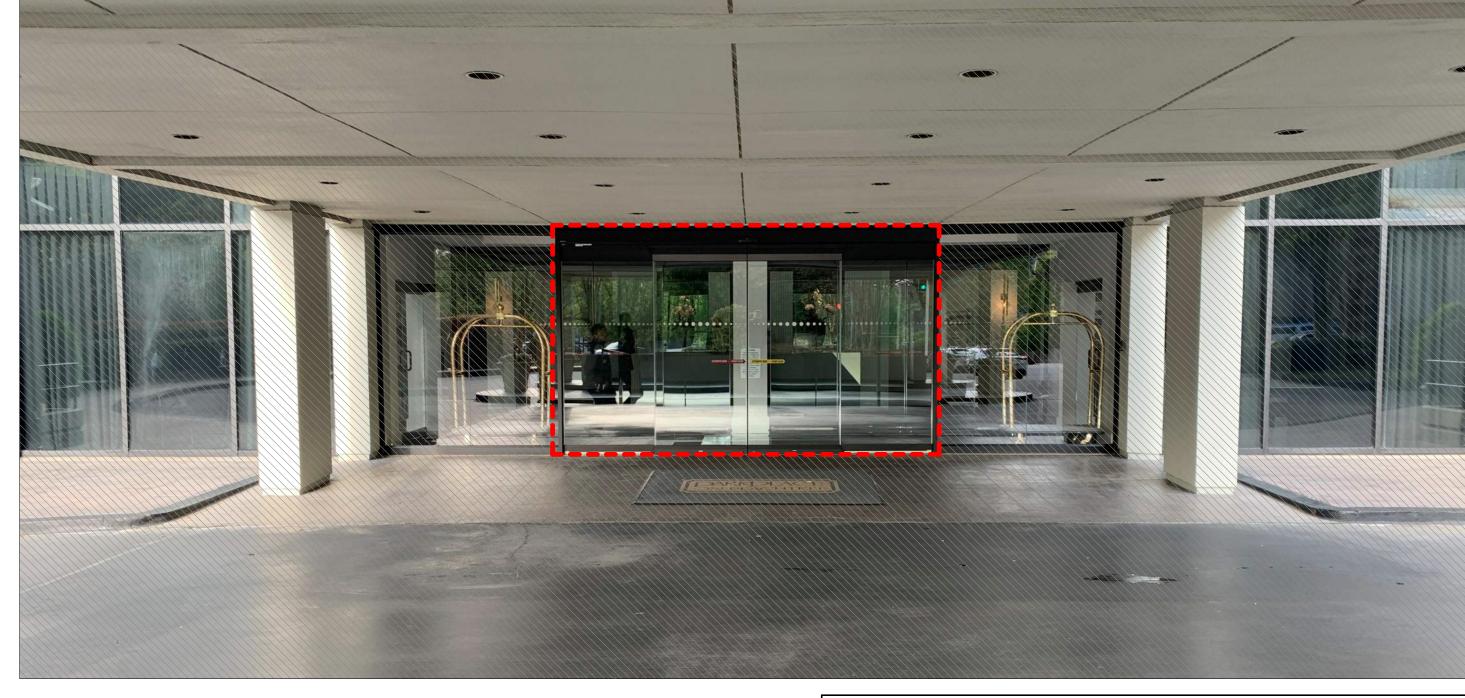

EXISTING STOREFRONT GENERAL NOTES GC TO CONFIRM ALL ROUGH OPENING DIMENSIONS REQUIRED FOR CURTAINWALL INFILL EXISTING STOREFRONT TO BE SALVAGED AND REINSTALLED EXISTING DOOR SPECIFICATION:
• ASSA ABLOY SL500 CGL COMMERCIAL ALL GLASS T TEMPERED GLASS ENTRY SYSTEM DARK BRONZE: ANO 303 AE

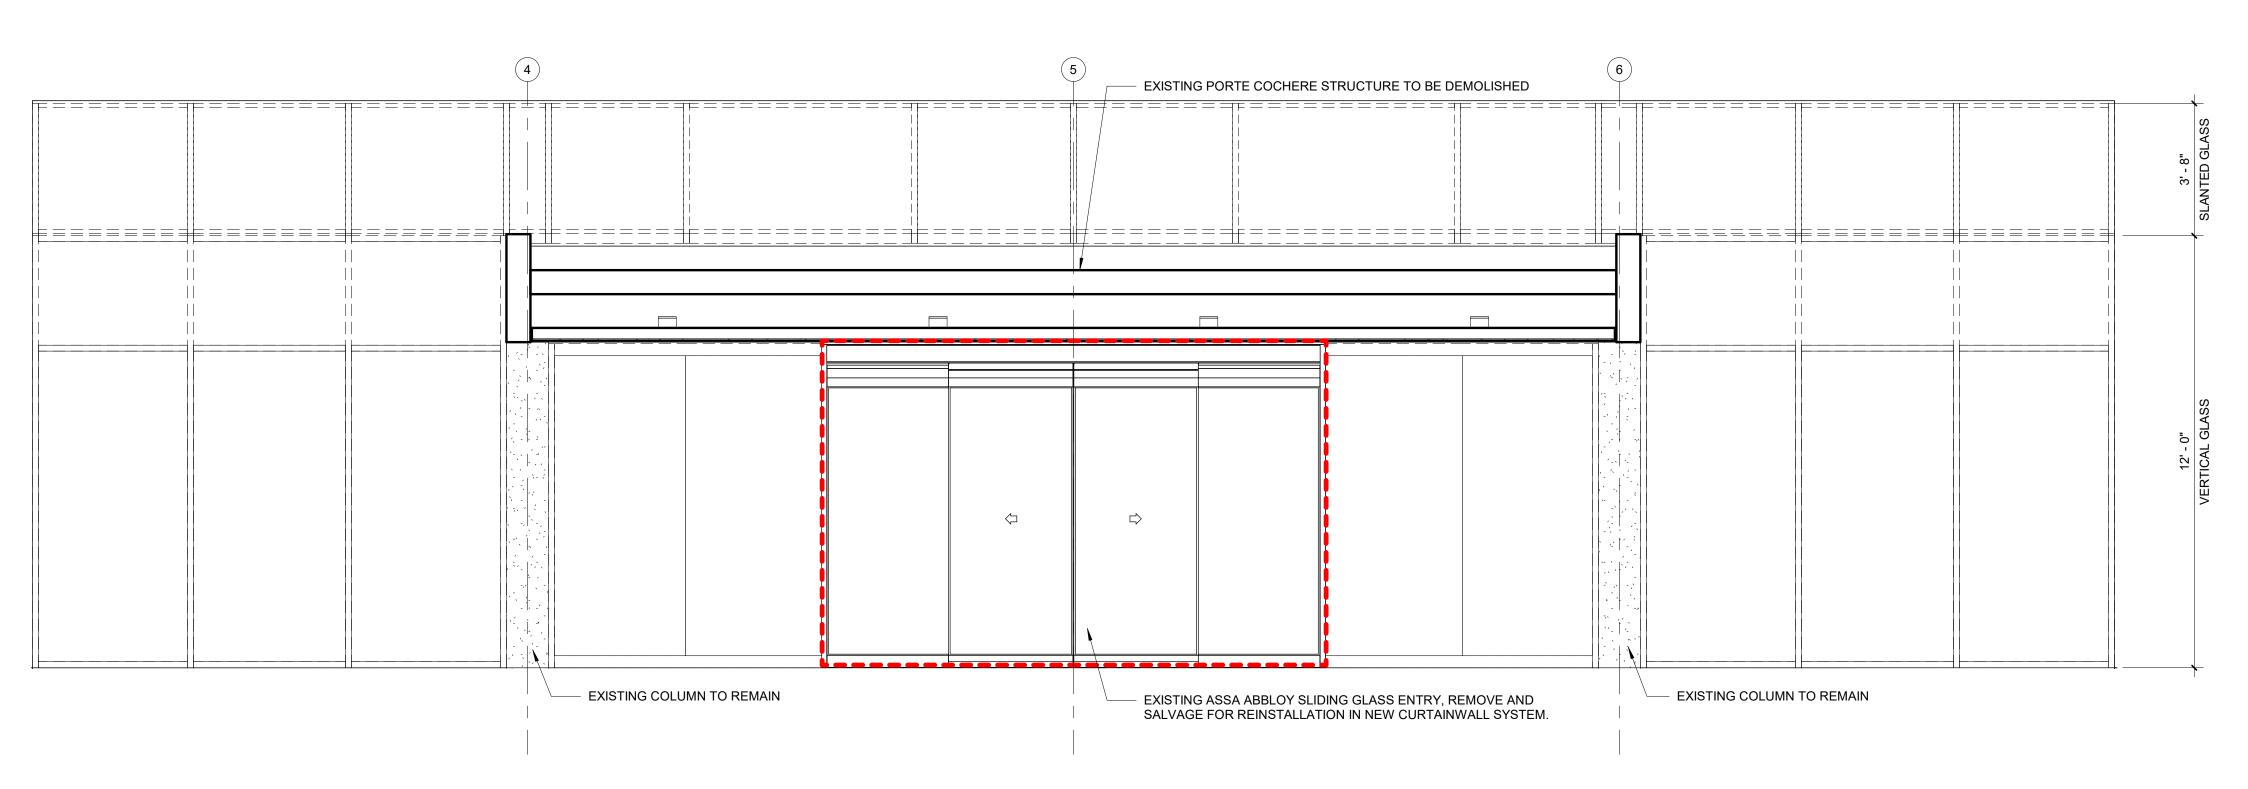

2 STOREFRONT ELEVATION - DEMO A502 SCALE: 3/8" = 1'-0"

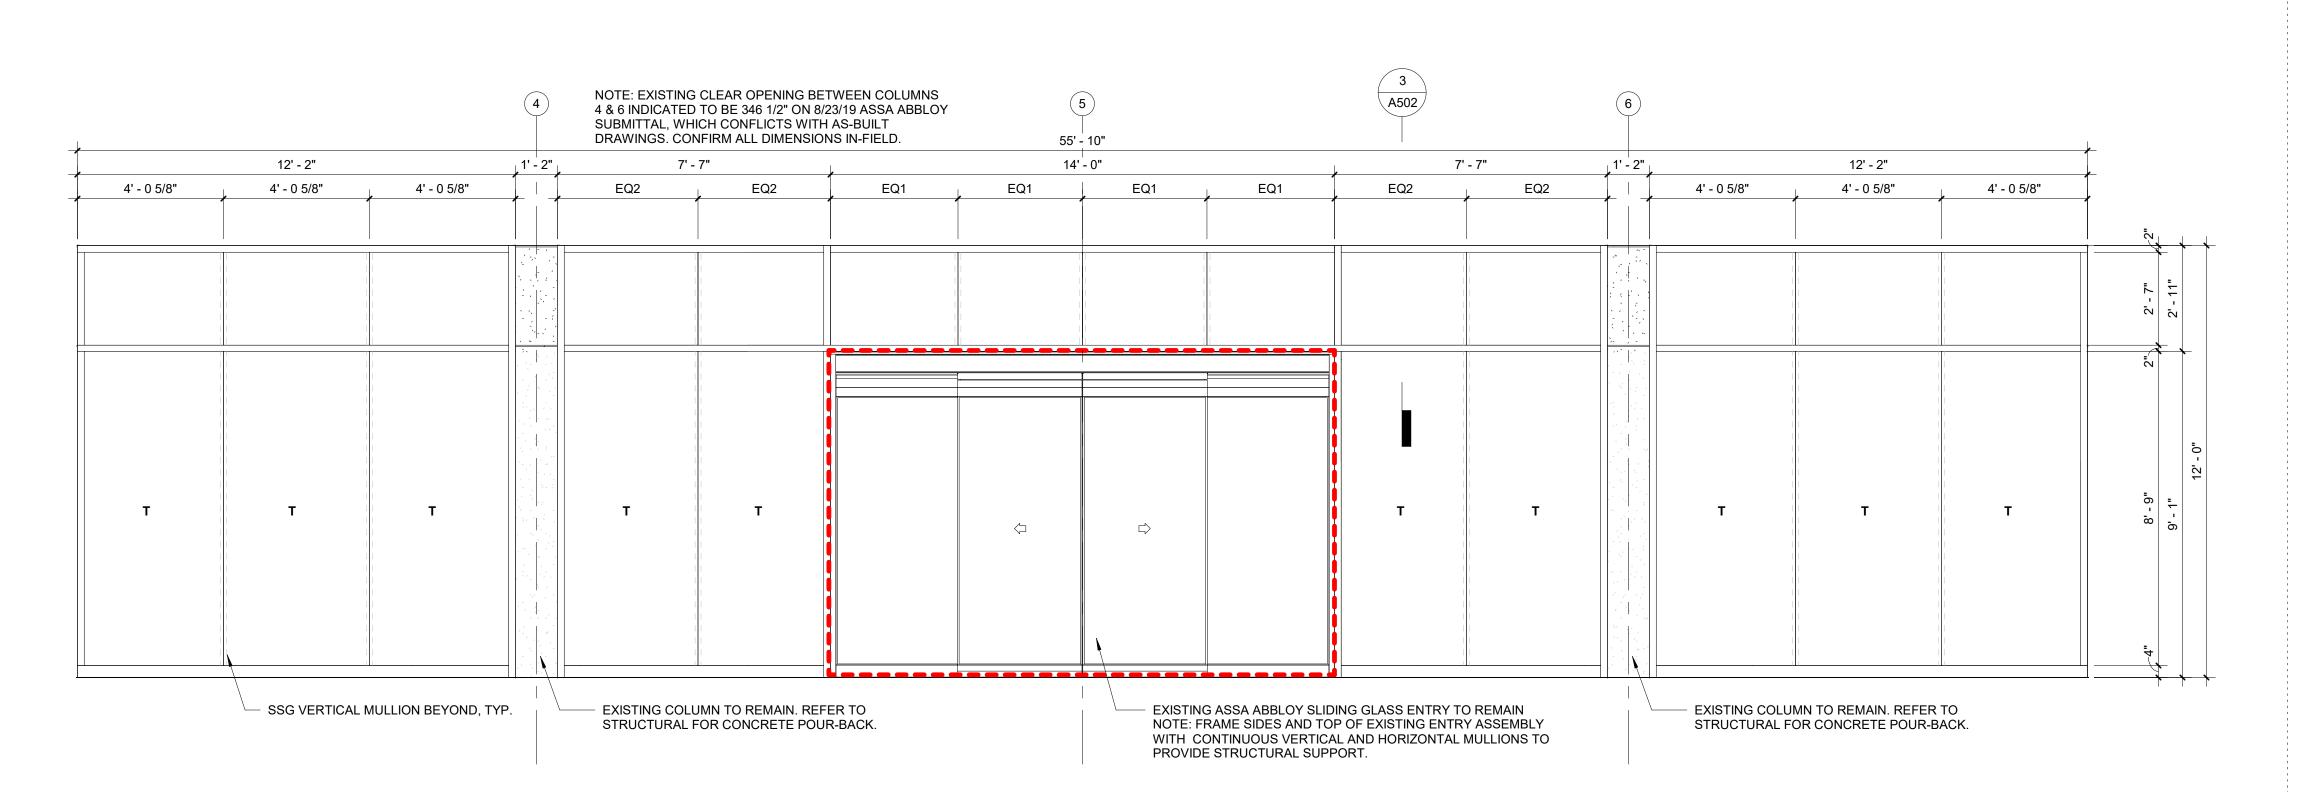

1 CURTAINWALL ELEVATION
A502 SCALE: 3/8" = 1'-0"

ARCHITECTS 83 Poplar Street NW ATLANTA, GA 30303 404.892.2443 voice mail@smithdalia.com

CONSULTANT:

PROJECT NO:

PROJECT TITLE:

Park Place

12/19/2023 10:59:42 AM

Construction Documents

OCTOBER 31, 2023

1 12/15/23 ADDENDUM 1

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SHEET TITLE:

GLAZING DETAILS

A502